


PUBLIC WORKS GARAGE

STRATHROY, ONTARIO

PROPOSED GARAGE

MIDDLESEX COUNTY
399 RIDOUT STREET NORTH
LONDON, ON N6A 2P1

ISSUED FOR TENDER
SEPTEMBER 6, 2017

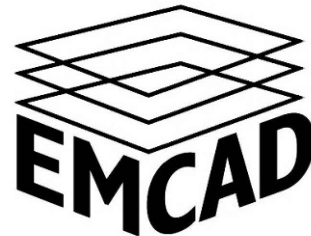





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- GENERAL NOTES:
- ALL PENETRATION THROUGH FIRE SEPARATIONS SHALL BE FIRE STOPPED IN ACCORDANCE WITH O.B.C. 3.1.8 & 3.1.9 AND ARCHITECTURAL PLANS AND SPECIFICATIONS.
 - CONTROLS FOR THE OPERATION OF BUILDING SERVICES OR SAFETY DEVICES INCLUDING SWITCHES, THERMOSTATS, INTERCOM SWITCHES, ALARMS AND KEYPADS, LOCATED WITHIN A BARRIER FREE PATH OF TRAVEL (AS OUTLINED IN O.B.C. 3.8.2.1.) SHALL BE MOUNTED AT 1200 MM ABOVE THE FINISHED FLOOR IN THE CASE OF A THERMOSTAT AND/OR A MANUAL PULL STATION AND NOT LESS THAN 900 MM AND NOT MORE THAN 1100 MM ABOVE THE FINISHED FLOOR IN THE CASE OF ALL OTHER CONTROLS, IN ACCORDANCE WITH O.B.C. 3.8.1.5. REFER TO ARCHITECTURAL DRAWINGS FOR AREAS DESIGNATED AS "BARRIER FREE PATH OF TRAVEL".
 - ALL MATERIALS AND SERVICES IN A CONCEALED SPACE USED AS A RETURN AIR PLENUM MUST COMPLY WITH O.B.C. 3.6.4.3 & 6.2.3.2, WHICH INCLUDES THAT THEY MUST HAVE A FLAME-SPREAD RATING OF NOT MORE THAN 25 AND A SMOKE DEVELOPED CLASSIFICATION NOT MORE THAN 50.
 - MECH. EQUIPMENT DIVISION OF RESPONSIBILITY:
UNLESS OTHERWISE NOTED ON THE DRAWINGS OR SPECIFICATIONS, MECHANICAL EQUIPMENT CONTROLS (THERMOSTATS, CONTROL PANELS, STARTERS, ETC.) AND LOW VOLTAGE WIRING AND CONDUIT ARE TO BE PROVIDED BY THE CONTRACTOR SUPPLYING THE EQUIPMENT BEING CONTROLLED. CONTROL WIRING IS TO BE 24 VOLT WHERE PRACTICAL UNLESS OTHERWISE NOTED ON THE DRAWINGS OR SPECIFICATIONS. ALL WIRING, CONDUITS AND DISCONNECTING MEANS 120 VOLT AND GREATER ARE THE RESPONSIBILITY OF THE ELECTRICAL CONTRACTOR. REVIEW REQUIREMENTS WITH LATEST SHOP DRAWINGS AND PERTINENT TRADES PRIOR TO ORDERING EQUIPMENT.
 - AS PER OBC SEC. 7.3.5.4 PROTECTION FROM FROST: WHERE PIPING MAY BE EXPOSED TO FREEZING CONDITIONS IT SHALL BE PROTECTED FROM THE EFFECTS OF FREEZING.
 - ALL PIPING IS TO BE INSTALLED WITH ADEQUATE CHANGE OF DIRECTION, EXPANSION JOINTS, GUIDES, AND ANCHORS, SO THAT THE PIPING AND EQUIPMENT WILL IN NO WAY BE STRAINED OR DISTORTED BY EXPANSION AND CONTRACTION. IT IS THE RESPONSIBILITY OF THE CONTRACTOR TO ENSURE THAT EXPANSION AND CONTRACTION IS ACCOUNTED FOR AND TO PROVIDE A LETTER TO EMCAD CONSULTING ENGINEERS (1995) INC. STATING THAT EXPANSION/CONTRACTION HAS BEEN ACCOUNTED FOR IN THE INSTALLATION PRIOR TO START-UP OF THE HEATING/COOLING SYSTEM AND DOMESTIC HOT WATER SYSTEM. REFER TO SPECIFICATION 230516 FOR MORE INFORMATION.
 - ALL EQUIPMENT, VALVES, BALANCING DAMPERS, FIRE DAMPERS, JUNCTION BOXES AND MAINTENANCE ITEMS LOCATED IN BULKHEADS, CEILINGS OR INACCESSIBLE SPACES SHALL BE PROVIDED WITH THE APPROPRIATELY RATED / INSULATED ACCESS PANELS. ACCESS PANELS TO BE PROVIDED BY CONTRACTOR INSTALLING THE COMPONENTS REQUIRING ACCESS.
 - IN ORDER TO MAINTAIN LONGEVITY OF COMBUSTIBLE CPVC PIPING SUCH AS BUT NOT LIMITED TO: BLAZEMASTER SPRINKLER PIPING, ALL CONTRACTORS ARE TO ENSURE NO PRODUCTS WITH RESIDUAL OILS SUCH AS BUT NOT LIMITED TO: ARMoured CABLES, DUCTWORK, METAL STUDS, METAL CONDUIT & COMMUNICATION CABLES, ARE RUN IN CONTACT WITH COMBUSTIBLE CPVC PIPES.
 - CONTRACTOR TO REVIEW ARCHITECTURAL REFLECTIVE CEILING PLANS FOR CEILING TYPES AND HEIGHTS ON ALL FLOOR PLANS.
 - MINIMUM HEIGHT FOR ALL PIPING, DUCTS, FIXTURES, CONDUITS, EQUIPMENT AND SIGNS IN THE PARKING AREA IS 6'-7" A.F.F. BARRIER-FREE PATH OF TRAVEL AND PARKING AREA MUST HAVE A MINIMUM HEIGHT OF 6'-11" A.F.F.


MEP DRAWING LIST

| | |
|------|----------------------------------|
| E0.1 | SITE PLAN - ELECTRICAL |
| E1.1 | MAIN FLOOR PLAN - ELECTRICAL |
| E1.2 | SECOND FLOOR PLAN - ELECTRICAL |
| E1.3 | SCHEDULES & DETAILS - ELECTRICAL |
| E1.4 | SPECIFICATIONS - ELECTRICAL |
| E1.5 | SITE PHOTOS - ELECTRICAL |
| M1.1 | MAIN FLOOR PLAN - PLUMBING |
| M1.2 | SCHEDULES & DETAILS - PLUMBING |
| M2.1 | MAIN FLOOR PLAN - HVAC |
| M2.2 | SECOND FLOOR PLAN - HVAC |
| M2.3 | SCHEDULES & DETAILS - HVAC |
| M2.4 | SCHEDULES & DETAILS - HVAC |
| M2.5 | SPECIFICATIONS - MECHANICAL |

| IMAGE | SYMBOL | CATALOG NUMBER | DESCRIPTION |
|---|---|--|---------------------|
|  |  | WALL SCONCE LITHONIA LIGHTING CAT# WSR LED 1 10A700/40K SR3 MVOLT | 24W LED 4000K |
|  |  | WALL SCONCE LITHONIA LIGHTING CAT# WSR LED 2 10A700/40K SR3 MVOLT | 47W LED 4000K |

EXTERIOR LIGHT SCHEDULE

SCALE: N.T.S.

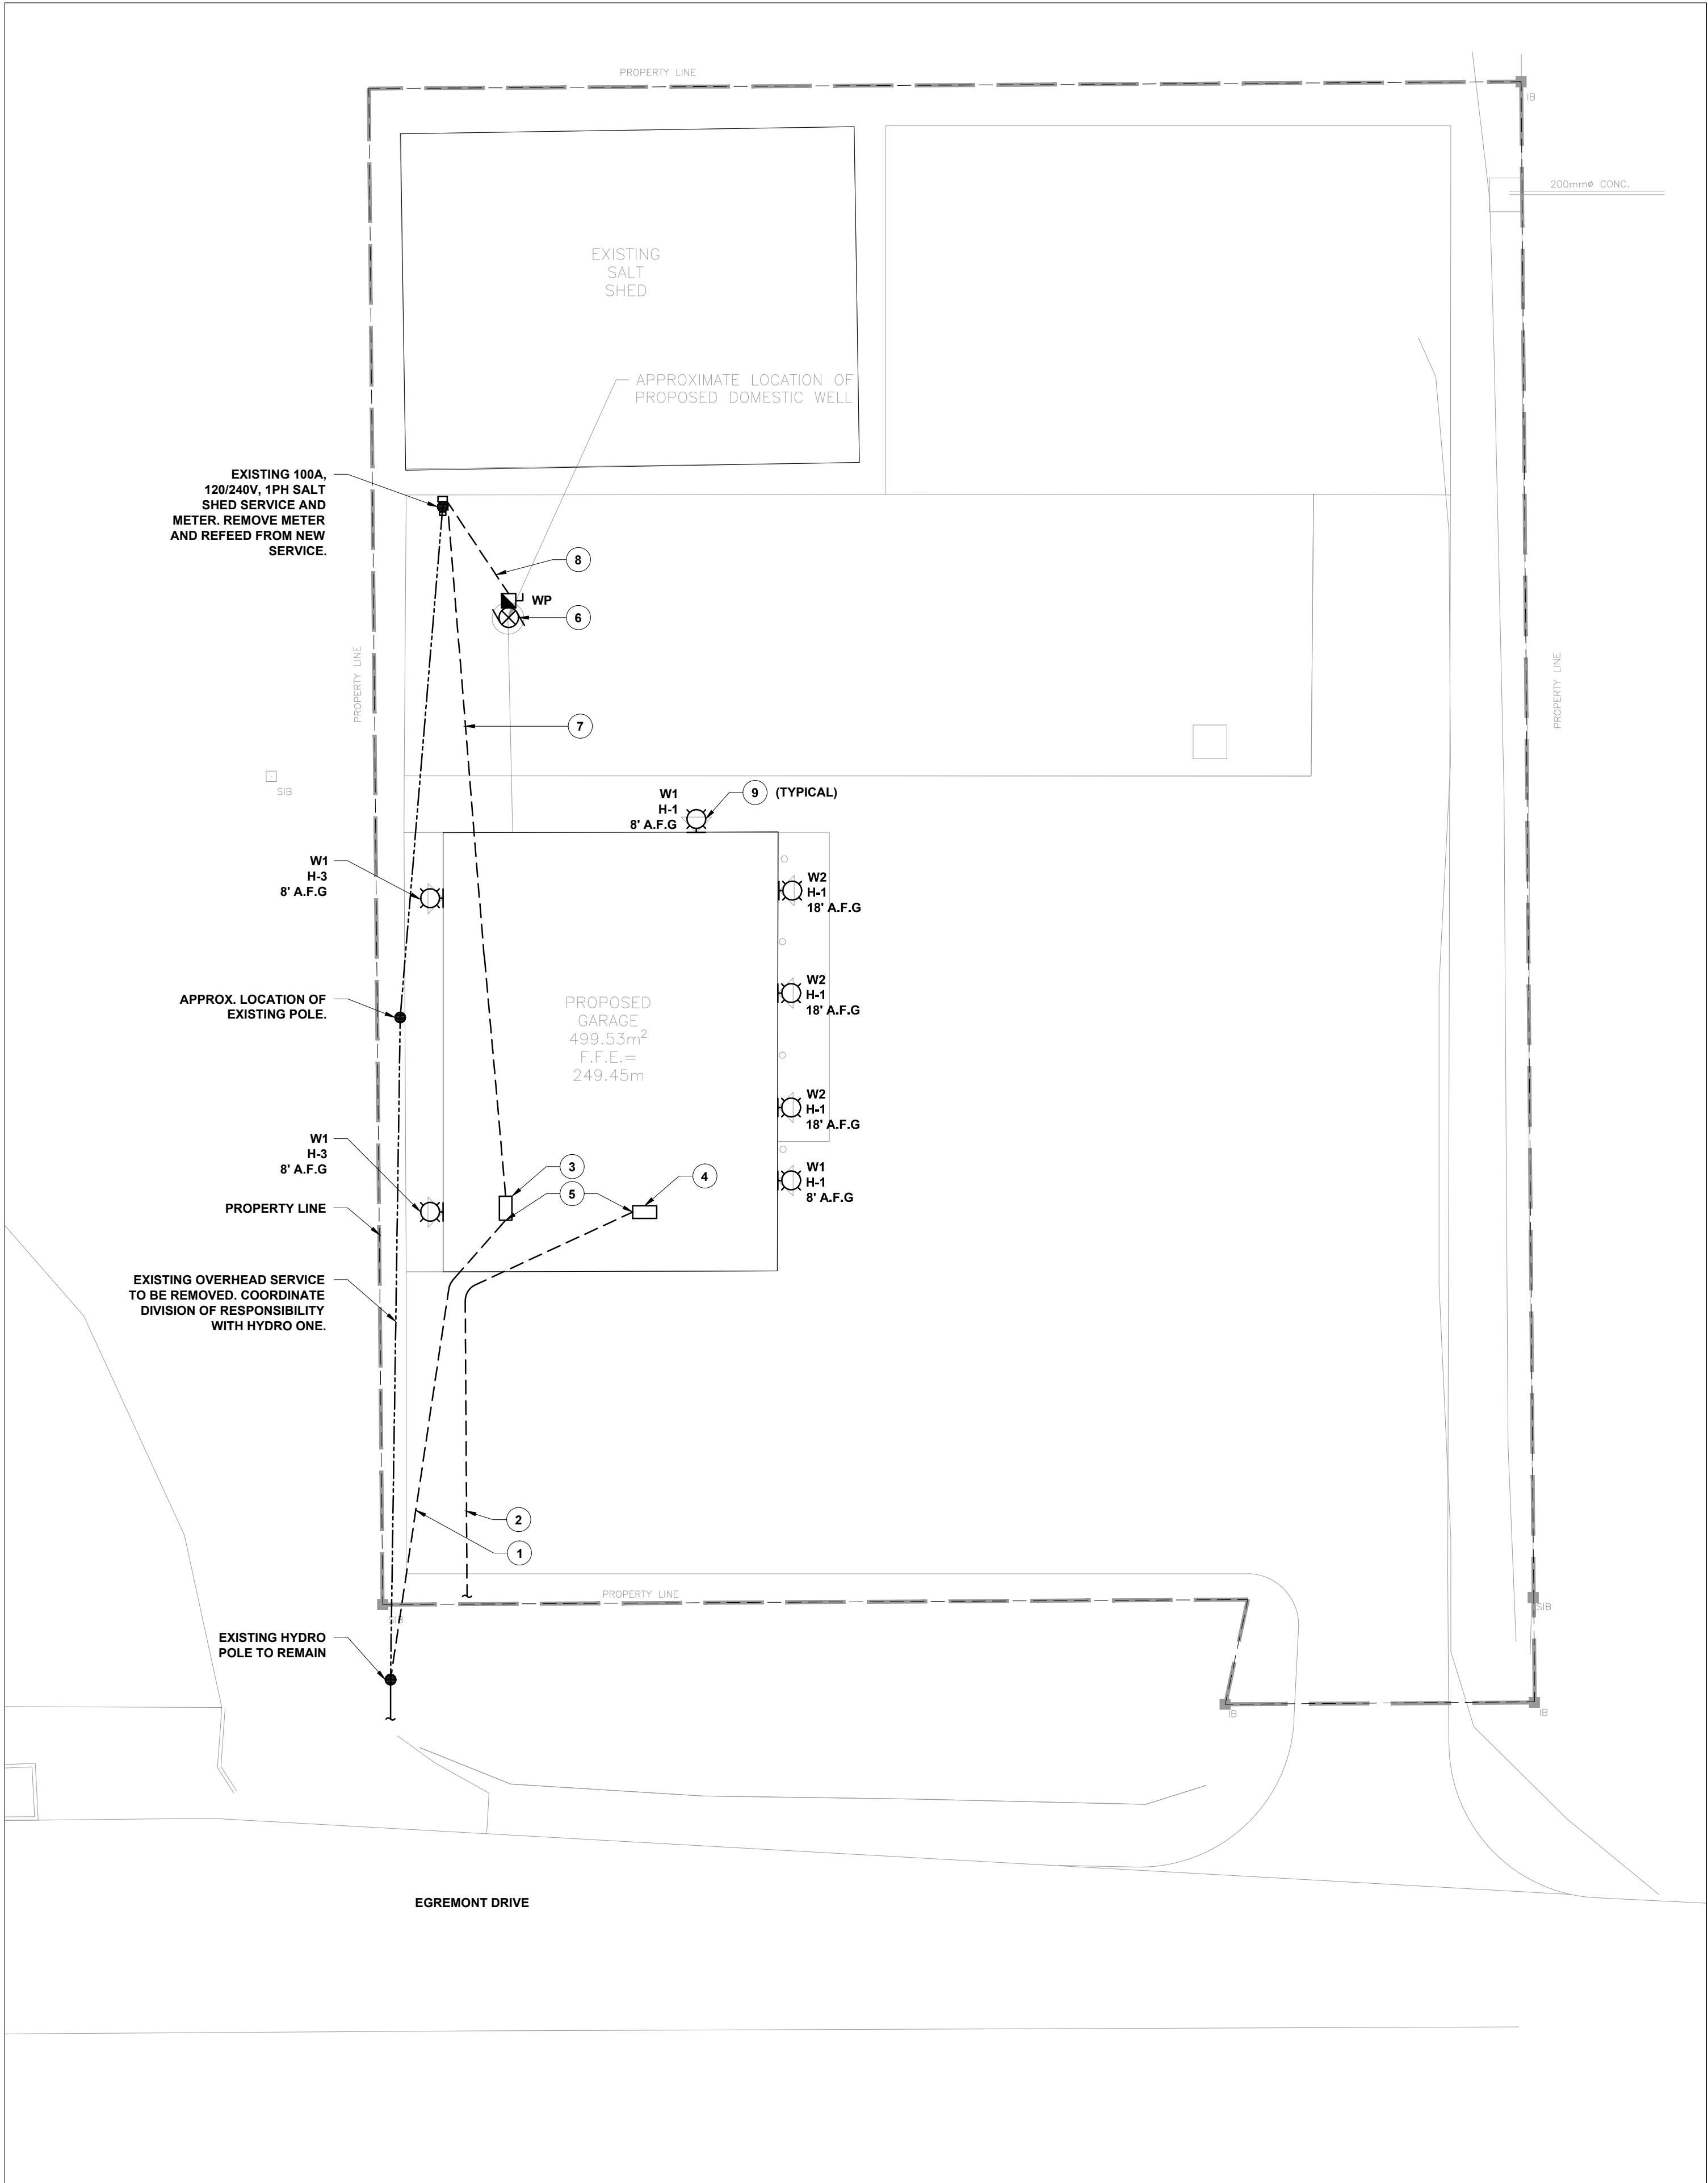

SITE PLAN

SCALE: 1:250

SERVICE UPGRADE SCOPE OF WORK:

- INTENT IS TO UPGRADE EXISTING 100A, 120/240V, SINGLE PHASE SERVICE FEEDING EXISTING SALT SHED WITH A NEW 200A, 120/208V, 3 PHASE SERVICE TO BE LOCATED IN PROPOSED GARAGE. EXISTING SALT SHED AND OTHER LOADS TO BE FED FROM NEW SERVICE.
- COORDINATE SCOPE OF WORK AND DIVISION OF RESPONSIBILITY WITH KC LECRAW AT HYDRO ONE. (kc.lecraw@hydroone.com).
- REMOVE DISUSED HYDRO POLES AS NECESSARY.
- PROVIDE NEW U/G CONDUIT AND WIRING FROM RISER POLE TO LOCATION OF NEW SERVICE EQUIPMENT.
- REFER TO DRAWINGS E1.3 AND E1.4 FOR SITE DISTRIBUTION DIAGRAM AND PHOTOS.


DRAWING NOTES (DENOTED BY):

- 4#250MCM AL. RWU90 IN 3" C installed PER OESC DIAGRAM D11 DETAIL 1. PROVIDE A SPARE 3" C FOR FUTURE EXPANSION. REFER TO DISTRIBUTION DIAGRAM FOR DETAILS.
- 2-4" INCOMING CONDUITS C/W 1/2" NYLON PULL CORDS FOR COMMUNICATION SERVICES. CAP AND STAKE AT THE PROPERTY LINE. COORDINATE EXACT LOCATIONS WITH UTILITIES.
- LOCATION OF SERVICE ENTRANCE EQUIPMENT WITHIN BUILDING. REFER TO DRAWING E1.1 FOR DETAILS.
- LOCATION OF COMMUNICATION EQUIPMENT LOCATED IN UTILITY ROOM. REFER TO DRAWING E1.1 FOR DETAILS.
- STUB UP CONDUIT AT SERVICE BOARD LOCATION. REFER TO DRAWING E1.1 FOR DETAILS.
- 1/2 HP, 208V, 1PH DOMESTIC WATER SUBMERSIBLE PUMP PROVIDED AND INSTALLED BY WELL CONTRACTOR. PROVIDE WIRING, CONNECTIONS AND DISCONNECTING MEANS PER OESC.
- PROVIDE WIRING AND CONDUIT FOR EXISTING SERVICE AT SALT SHED. 3#10 AWG RW90 AL RW90 IN 2" C. REFER TO DISTRIBUTION DIAGRAM FOR DETAILS.
- PROVIDE WIRING AND CONDUIT FOR DOMESTIC WELL PUMP. 2#10 AWG RW90 Cu. IN 1" C.
- REFER TO ARCHITECTURAL DRAWINGS FOR ELEVATIONS.


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
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|-----|-------------------------|-----------|
| 0 | ISSUED FOR OWNER REVIEW | AUG 25'17 |
| No. | REVISION | DATE |

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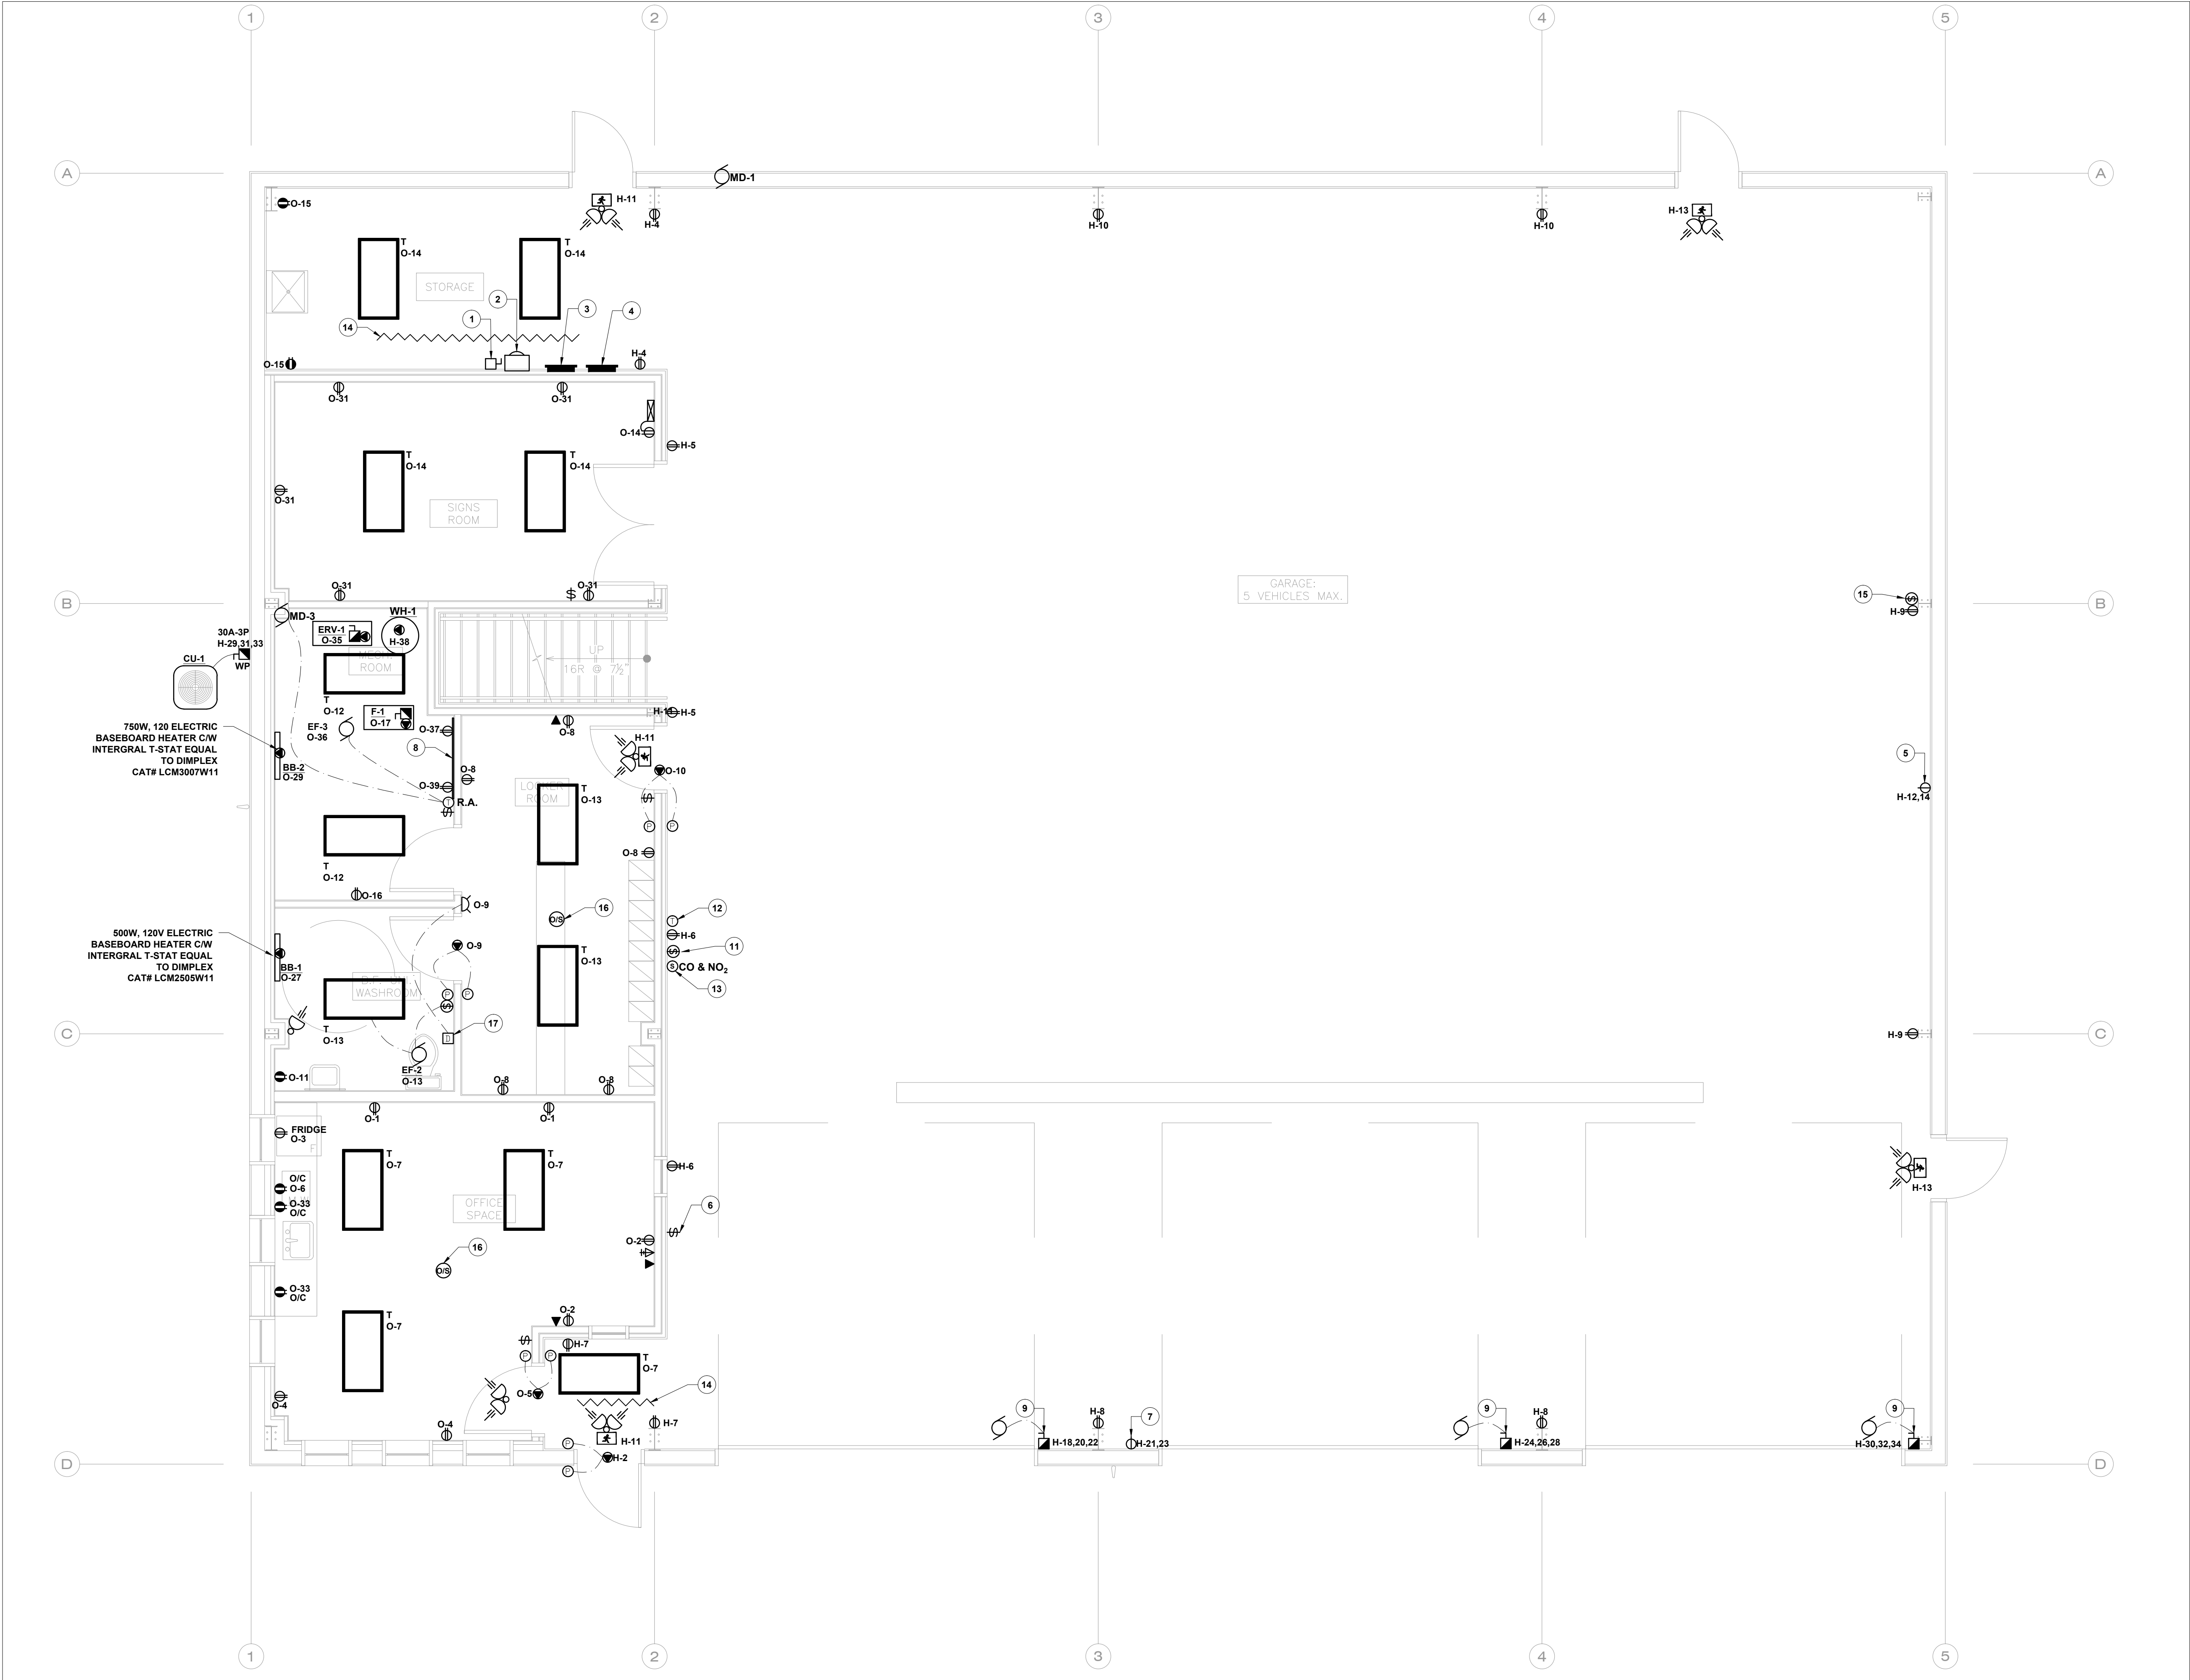


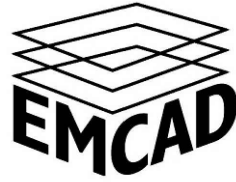

PROJECT # 17089

PUBLIC WORKS GARAGE
3550 EGREMONT DRIVE
STRATHROY ONTARIO

| SITE PLAN -ELECTRICAL | |
|--------------------------|---------------------------------------|
| DRAWN: TP | SCALE: 1:250 |
| DESIGN: TP | CHECKED: WA |
| DRAWING No. | REVISION: E0.1 R1 |



MAIN FLOOR PLAN

SCALE: 1/4" = 1' - 0"



DRAWING NOTES (DENOTED BY):

1. BUILDING MAIN DISCONNECT 200A, 120/208V, 3PH, 4W, FUSED AT 200A CLASS J.
2. 200A, 120/208V, 3PH, 4W METER SOCKET PER HYRDO ONE'S REQUIREMENTS.
3. *PANEL-H* 200A, 120/208, 3PH, 4W, M.L.O., 42 CCT.
4. *PANEL-O* 100A, 120/208V, 3PH, 4W, M.L.O., 42 CCT.
5. 30A, 240V WELDING RECEPTACLE. COORDINATE LOCATIONS ON SITE WITH G.C.
6. SWITCH TO CONTROL LIGHTS IN GARAGE.
7. 20A, 240V WASHER RECEPTACLE. OWNER TO CONFIRM LOCATION.
8. COMMUNICATION BACKBOARD 4' x 8' x 3/4".
9. GARAGE DOOR OPENER LOCATION. COORDINATE REQUIREMENTS WITH OWNER.
10. RESERVED.
11. OCCUPANCY SENSOR SHALL BE EQUAL TO LEVITON MODEL # OSSMT-MDX-DUAL TECH WITH 30 MIN TIME DELAY. INTERLOCKED WITH MD-1 (LOW LEVEL) AND MD-1 & EF-1 (HIGH LEVEL). COORDINATE ON SITE WITH MECHANICAL CONTRACTOR.
12. T-STAT CONNECTED TO IR-1 AND IR-2 ON SECOND FLOOR. PROVIDED BY OTHERS.
13. CO/NO₂ MONITORING SYSTEM COMPLETE WITH OCCUPANCY SENSOR TO INTERLOCK WITH MD-2 AND EF-4 ON SECOND FLOOR. SENSORS ARE PROVIDED BY MECHANICAL AND WIRED BY ELECTRICAL. REFER TO DRAWING E1.3 FOR DETAILS. PROVIDE CONTACTORS AS NECESSARY. FED FROM CIRCUIT H-16. COORDINATE ON SITE WITH MECHANICAL CONTRACTOR.
14. PROVIDE WIRING AND CONNECTION FOR HEAT TRACE PROVIDED BY MECHANICAL CONTRACTOR. ENSURE GFCI PROTECTION. FED FROM H-19 & H-36. COORDINATE LOCATIONS ON-SITE WITH MECHANICAL CONTRACTOR.
15. OCCUPANCY SENSOR SHALL BE EQUAL TO LEVITON MODEL # OSSMT-MDX-DUAL TECH WITH 30 MIN TIME DELAY. INTERLOCKED WITH MD-1 (LOW LEVEL) AND MD-2 & EF-4 (HIGH LEVEL). COORDINATE ON SITE WITH MECHANICAL CONTRACTOR.
16. OCCUPANCY SENSOR SHALL BE EQUAL TO LEVITON MODEL # Q2C10-MDW.
17. EMERGENCY DISTRESS BUTTON WITH HORN/STROBE LOCATED OUTSIDE B.F. WASHROOM. REFER TO DRAWING E1.3 FOR DETAILS.

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| 2 | ISSUED FOR TENDER | SEPT 6'17 |
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| No. | REVISION | DATE |


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PUBLIC WORKS GARAGE
3550 EGREMONT DRIVE
STRATHROY ONTARIO

**MAIN FLOOR PLAN
-ELECTRICAL**
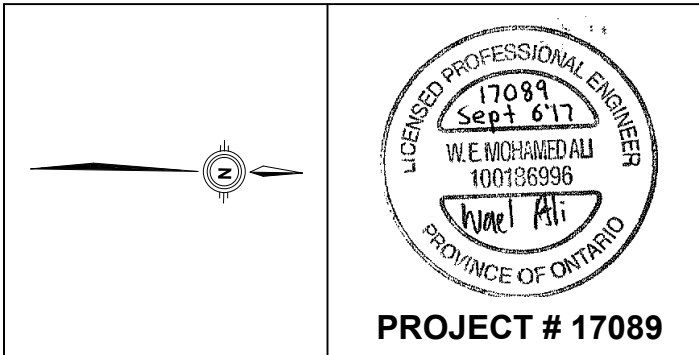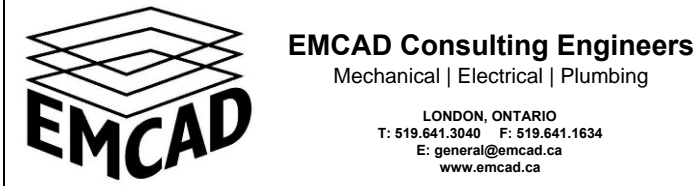
| | |
|-------------|-----------------------|
| DRAWN: TP | SCALE: 1/4" = 1' - 0" |
| DESIGN: TP | CHECKED: WA |
| DRAWING No. | REVISION: |
| E1.1 | R2 |



SECOND FLOOR PLAN
SCALE: 1/4" = 1' - 0"

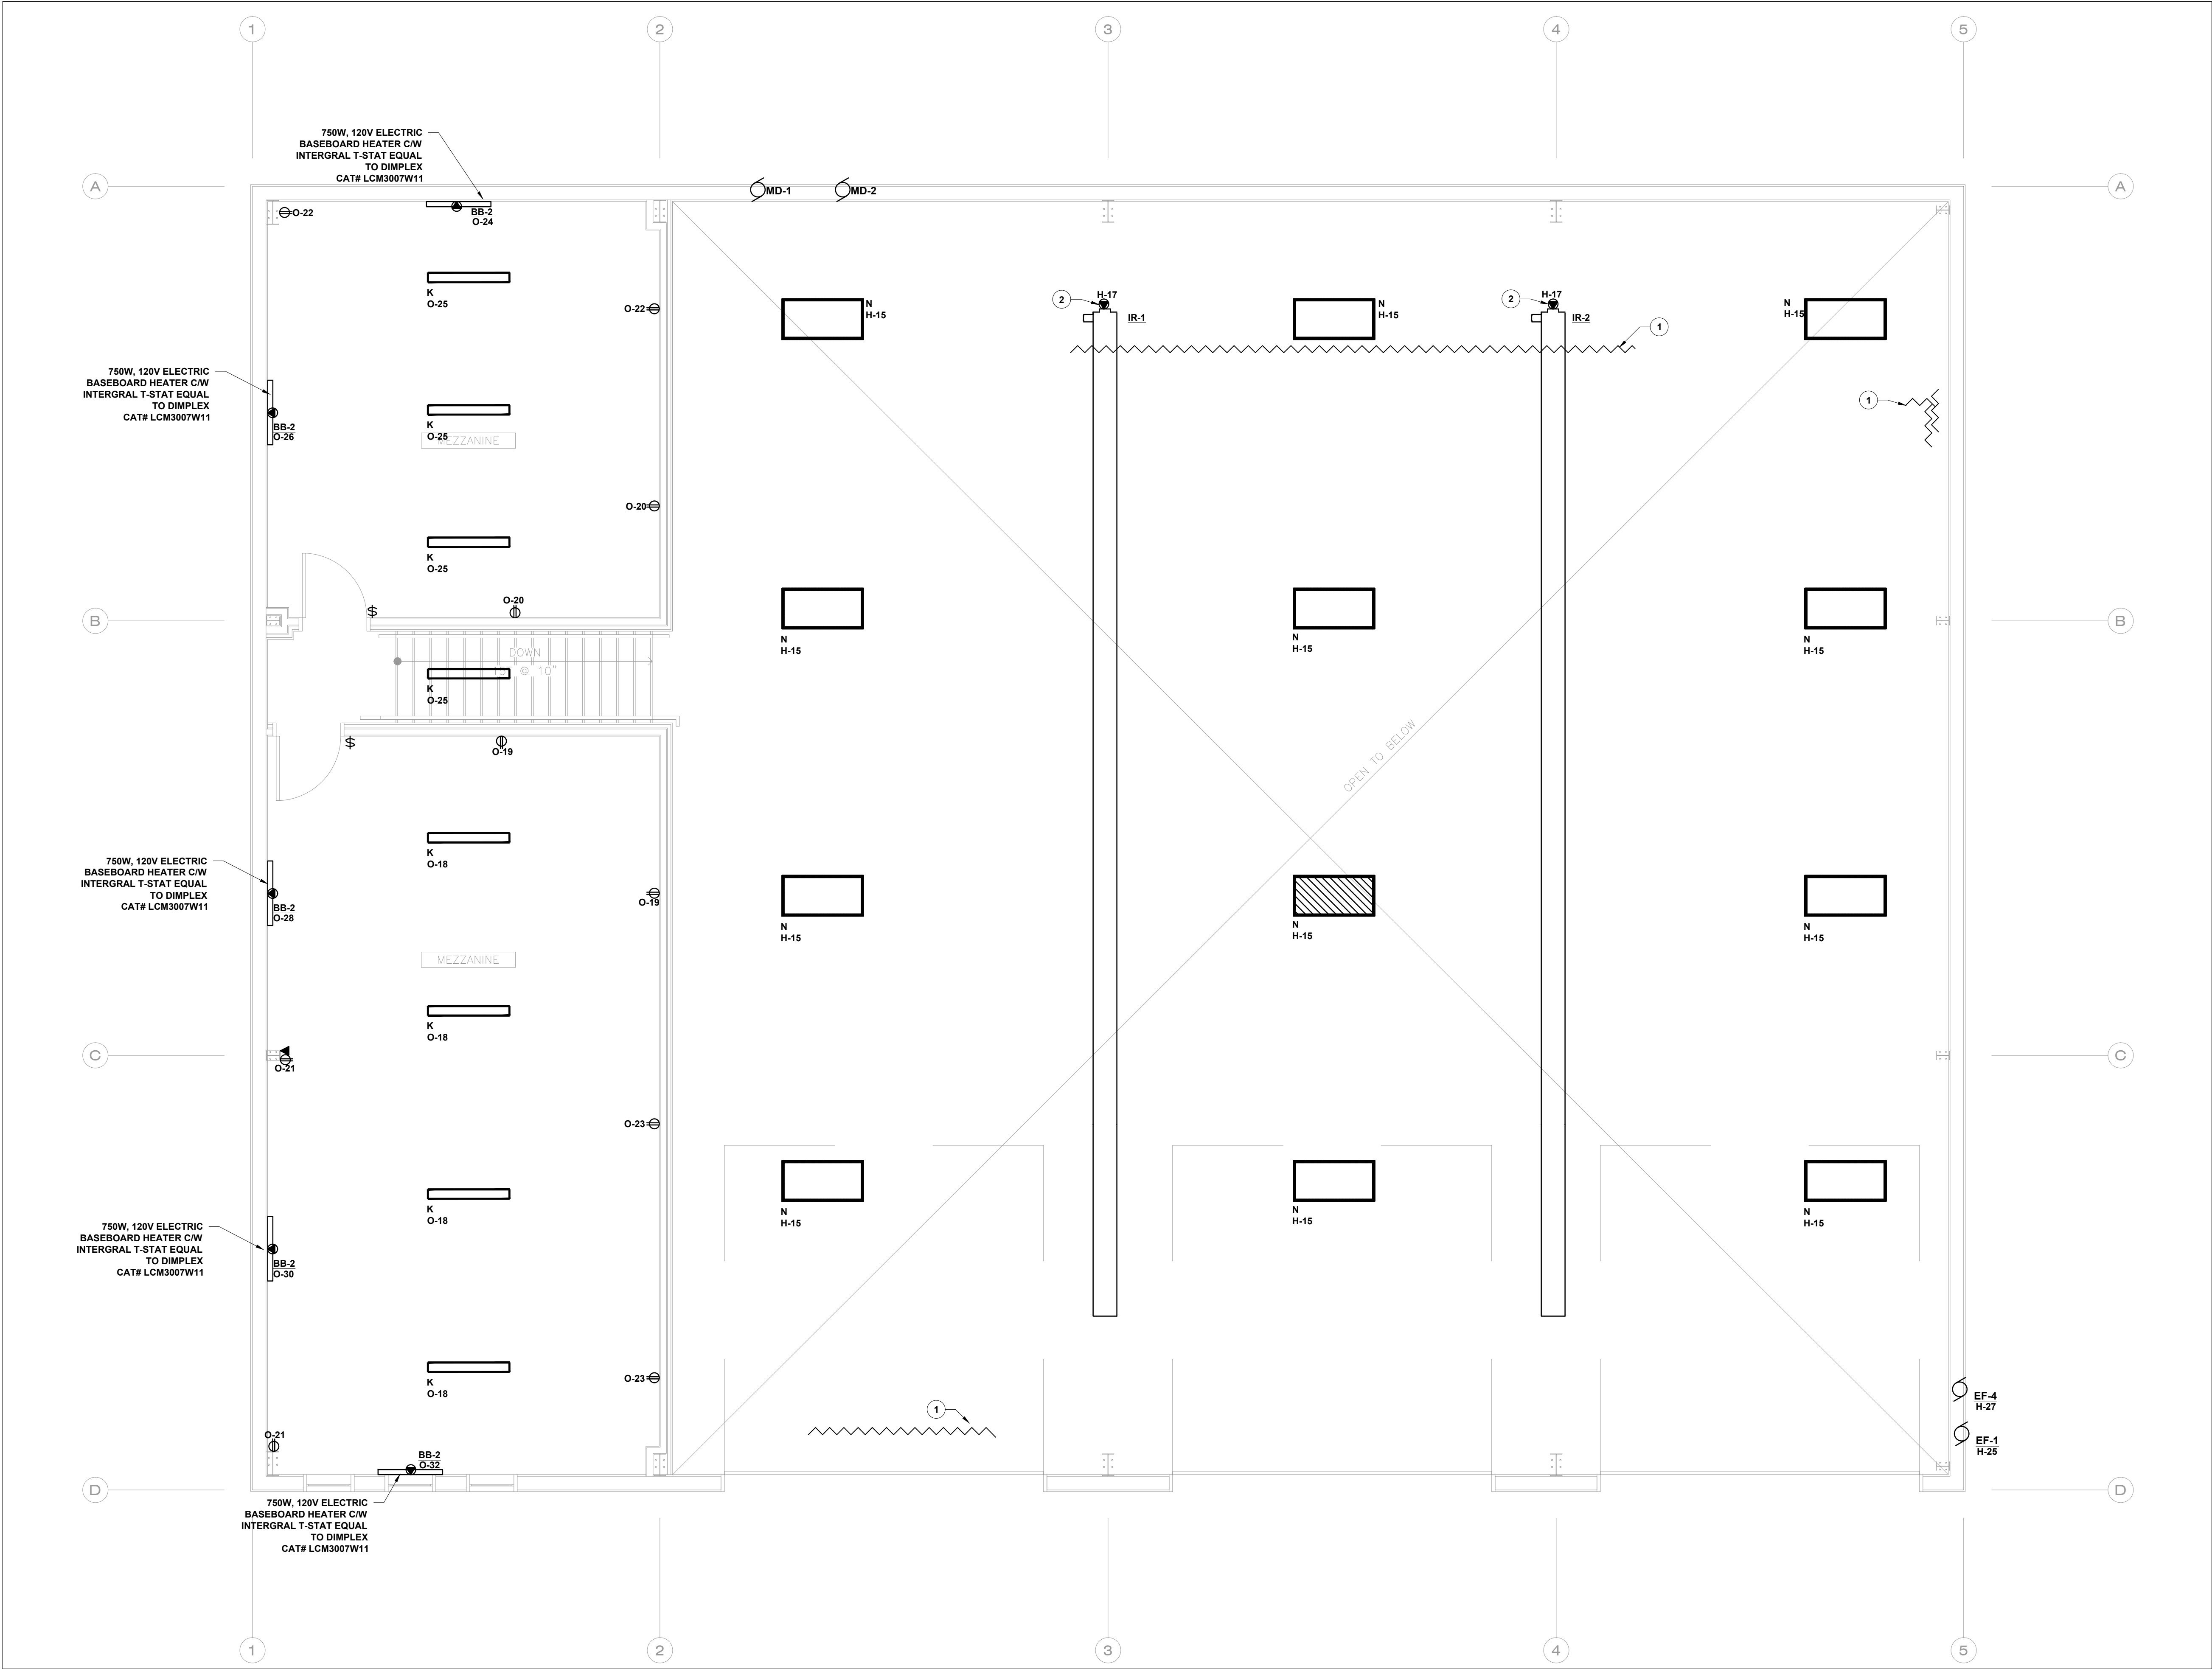- DRAWING NOTES (DENOTED BY): #
1. PROVIDE WIRING AND CONNECTION FOR HEAT TRACE PROVIDED BY MECHANICAL CONTRACTOR. ENSURE GFCI PROTECTION. FED FROM H-19 & H-36. COORDINATE LOCATIONS ON-SITE WITH MECHANICAL CONTRACTOR.
 2. INFRARED GAS FIRED HEATER. PROVIDE 120V DIRECT CONNECT. COORDINATE LOCATIONS ON SITE WITH MECHANICAL CONTRACTOR.

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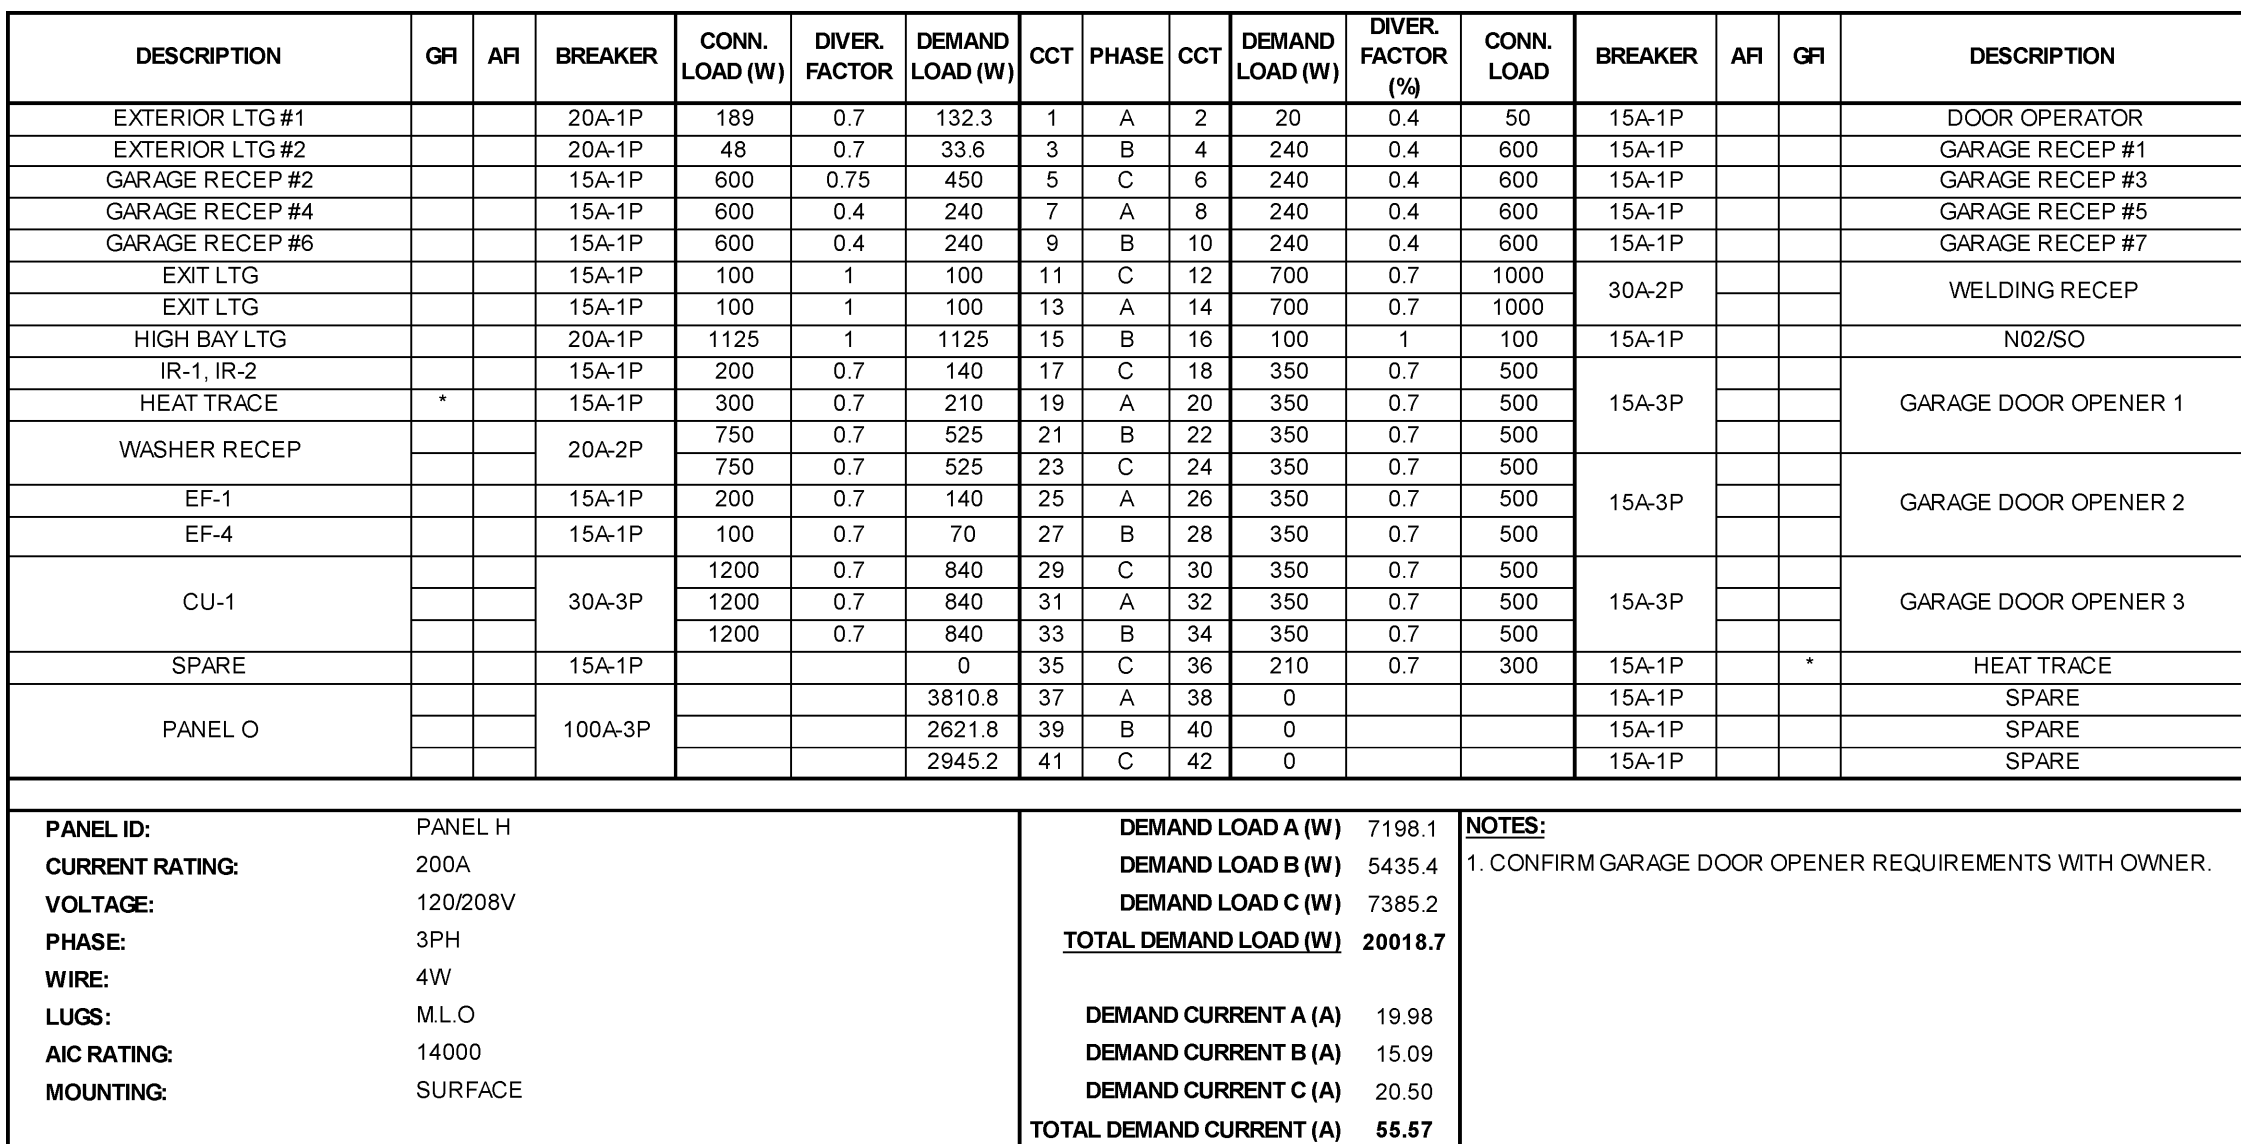
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PROFESSIONAL ENGINEER
17089
W. C. MOHAMMADALI
100108996
PROVINCE OF ONTARIO
PROJECT # 17089

PUBLIC WORKS GARAGE
3550 EGREMONT DRIVE
STRATHROY ONTARIO

SECOND FLOOR PLAN
-ELECTRICAL


















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| E1.2 | R2 |

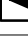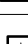


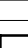
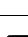


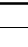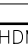


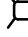

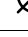
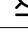




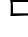









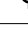


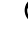

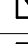




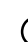




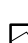





| DIVISION OF RESPONSIBILITY | | |
|---|-------------|--------------|
| ITEM | SUPPLIED BY | INSTALLED BY |
| 1. LIGHT FIXTURES | CONTRACTOR | CONTRACTOR |
| 2. COMMUNICATIONS RACEWAY (CONDUIT & BACKBOX) | CONTRACTOR | CONTRACTOR |
| 3. COMMUNICATIONS CABLING | OWNER | OWNER |
| 4. COMMUNICATIONS OUTLET AND COVER PLATES | CONTRACTOR | CONTRACTOR |

FAN CONTROL SCHEMATIC

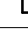N.T.S.
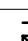
| LEGEND | |
|---|-----------------------------|
| SYMBOL | DESCRIPTION |
| COMMUNICATION | |
|  | CATV |
|  | TELEPHONE WALL OUTLET |
|  | TELEPHONE/DATA WALL OUTLET |
|  | DATA WALL OUTLET |
|  | TELEPHONE FLOOR OUTLET |
|  | TELEPHONE/DATA FLOOR OUTLET |
|  | DATA FLOOR OUTLET |
|  | INTERCOM |
|  | WALL PA |
|  | CEILING PA |
|  | CCTV |
|  | JUNCTION BOX |
|  | ELECTRIC THERMOSTAT |
|  | CO SENSOR |
|  | WIRELESS ACCESS POINT |
|  | CARD READER ROUGH-IN |
|  | HDMI CONNECTION |
| THIS IS A STANDARD LEGEND ALL SYMBOLS MAY NOT NECESSARILY BE USED ON DRAWINGS | |

| LEGEND | |
|---|-------------------------------------|
| SYMBOL | DESCRIPTION |
| LIGHTING | |
|  | 1X4 LIGHT FIXTURE |
|  | 2X2 LIGHT FIXTURE |
|  | 2X4 LIGHT FIXTURE |
|  | 1X4 RECESSED LIGHT FIXTURE |
|  | 2X2 RECESSED LIGHT FIXTURE |
|  | 2X4 RECESSED LIGHT FIXTURE |
|  | 1X4 EMERGENCY LIGHT FIXTURE |
|  | 2X2 EMERGENCY LIGHT FIXTURE |
|  | 2X4 EMERGENCY LIGHT FIXTURE |
|  | 4' STRIP LIGHT FIXTURE |
|  | TRACK LIGHTING |
|  | POLE MOUNTED LIGHT FIXTURE |
|  | CEILING MOUNTED LIGHT FIXTURE |
|  | CEILING RECESSED LIGHT FIXTURE |
|  | WALL SCONCE |
|  | 2X2 NIGHT LIGHT FIXTURE |
|  | 2X4 NIGHT LIGHT FIXTURE |
| SWITCHES | |
|  | SINGLE SWITCH 347V 15A |
|  | TWO GANG SWITCH |
|  | THREE GANG SWITCH |
|  | FOUR GANG SWITCH |
|  | THREE-WAY SWITCH 120V 15A |
|  | DIMMER SWITCH |
|  | 10/20/30/60 MINUTE TIMER |
|  | OCCUPANCY SENSOR |
|  | OCCUPANCY SENSOR SWITCH |
| RECEPTACLES | |
|  | SINGLE WALL RECEPTACLE |
|  | DUPLEX RECEPTACLE 120V, 15A |
|  | QUADPLEX RECEPTACLE 120V, 15A |
|  | HALF SWITCH RECEPTACLE 120V, 15A |
|  | G.F.C.I. RECEPTACLE 120V, 15A |
|  | 50A RANGE RECEPTACLE |
|  | 30A DRYER RECEPTACLE |
|  | DIRECT CONNECT |
|  | SINGLE FLOOR RECEPTACLE |
|  | DUPLEX FLOOR RECEPTACLE |
|  | QUAD FLOOR RECEPTACLE |
| EQUIPMENT | |
|  | POWER/LIGHTING PANEL |
|  | SINGLE PHASE MOTOR |
|  | THREE PHASE MOTOR |
|  | FUSED DISCONNECT |
|  | NON-FUSED DISCONNECT |
|  | MAGNETIC STARTER |
|  | MANUAL STARTER |
|  | STARTER-COMB-FUSED |
|  | START-COMB-NON-FUSED |
|  | HEAT TRACE |
| THIS IS A STANDARD LEGEND ALL SYMBOLS MAY NOT NECESSARILY BE USED ON DRAWINGS | |

| | |
|---|---------------|
| <h1 style="text-align: center;">SCHEDULES & DETAILS</h1> <h2 style="text-align: center;">-ELECTRICAL</h2> | |
| DRAWN: TP | SCALE: N.T.S. |
| DESIGN: TP | CHECKED: WA |
| DRAWING No. | REVISION: |
| <h1>E1.3</h1> | <h1>R2</h1> |

| | |
|-------------------------------|----------------------------|
| DRAWN: TP | SCALE: N.T.S. |
| DESIGN: TP | CHECKED: WA |
| DRAWING No. E1.3 | REVISION: R2 |



PHOTO 1: OVERALL SITE

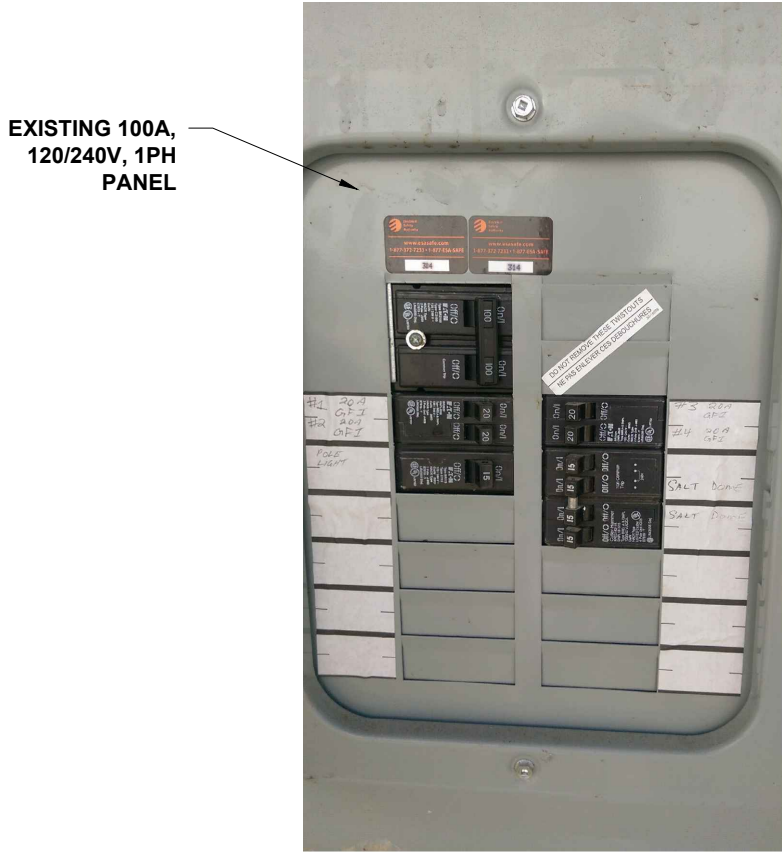


PHOTO 3: EXISTING SALT SHED PANEL

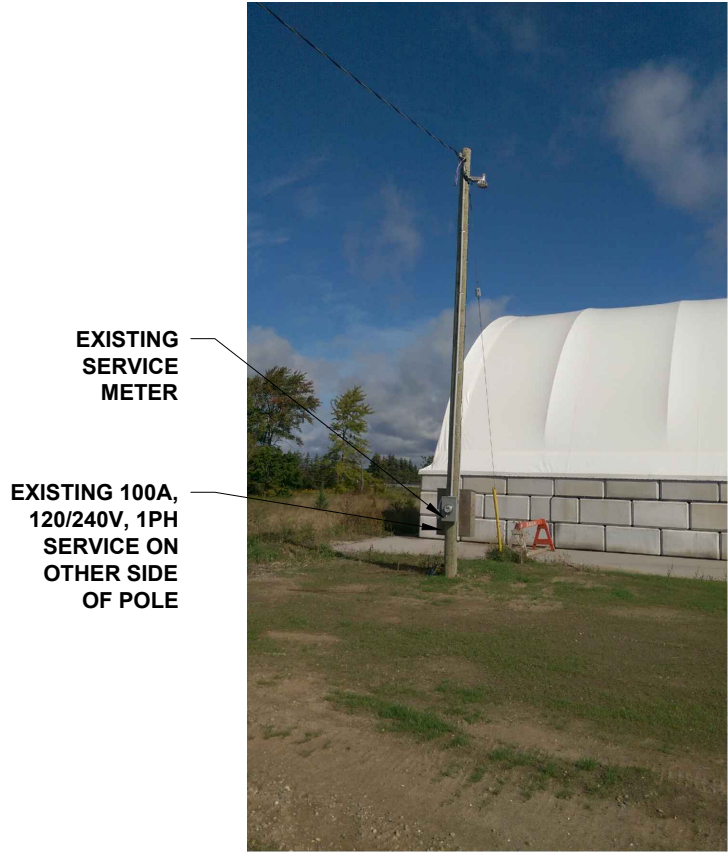


PHOTO 2: EXISTING SALT SHED SERVICE

THE CONTRACTOR SHALL VERIFY ALL DIMENSIONS ON SITE. DO NOT SCALE DRAWINGS. DRAWINGS AND SPECIFICATIONS REMAIN THE PROPERTY OF THE ENGINEER AS INSTRUMENTS OF HIS SERVICE AND MUST BE RETURNED AT HIS REQUEST.

| 0 | ISSUED FOR TENDER | SEPT 6'17 |
|-----|-------------------|-----------|
| No. | REVISION | DATE |

MIDDLESEX COUNTY
399 RIDOUT STREET NORTH
LONDON, ON N6A 2P1



EMCAD Consulting Engineers
Mechanical | Electrical | Plumbing
LONDON, ONTARIO
T: 519.841.1200 F: 519.841.1634
E: general@emcad.ca
www.emcad.ca




PROJECT # 17089

PUBLIC WORKS GARAGE
3550 EGREMONT DRIVE
STRATHROY ONTARIO

SITE PHOTOS
-ELECTRICAL

| | |
|-------------|---------------|
| DRAWN: TP | SCALE: N.T.S. |
| DESIGN: TP | CHECKED: WA |
| DRAWING No. | REVISION: |
| E1.5 | R0 |

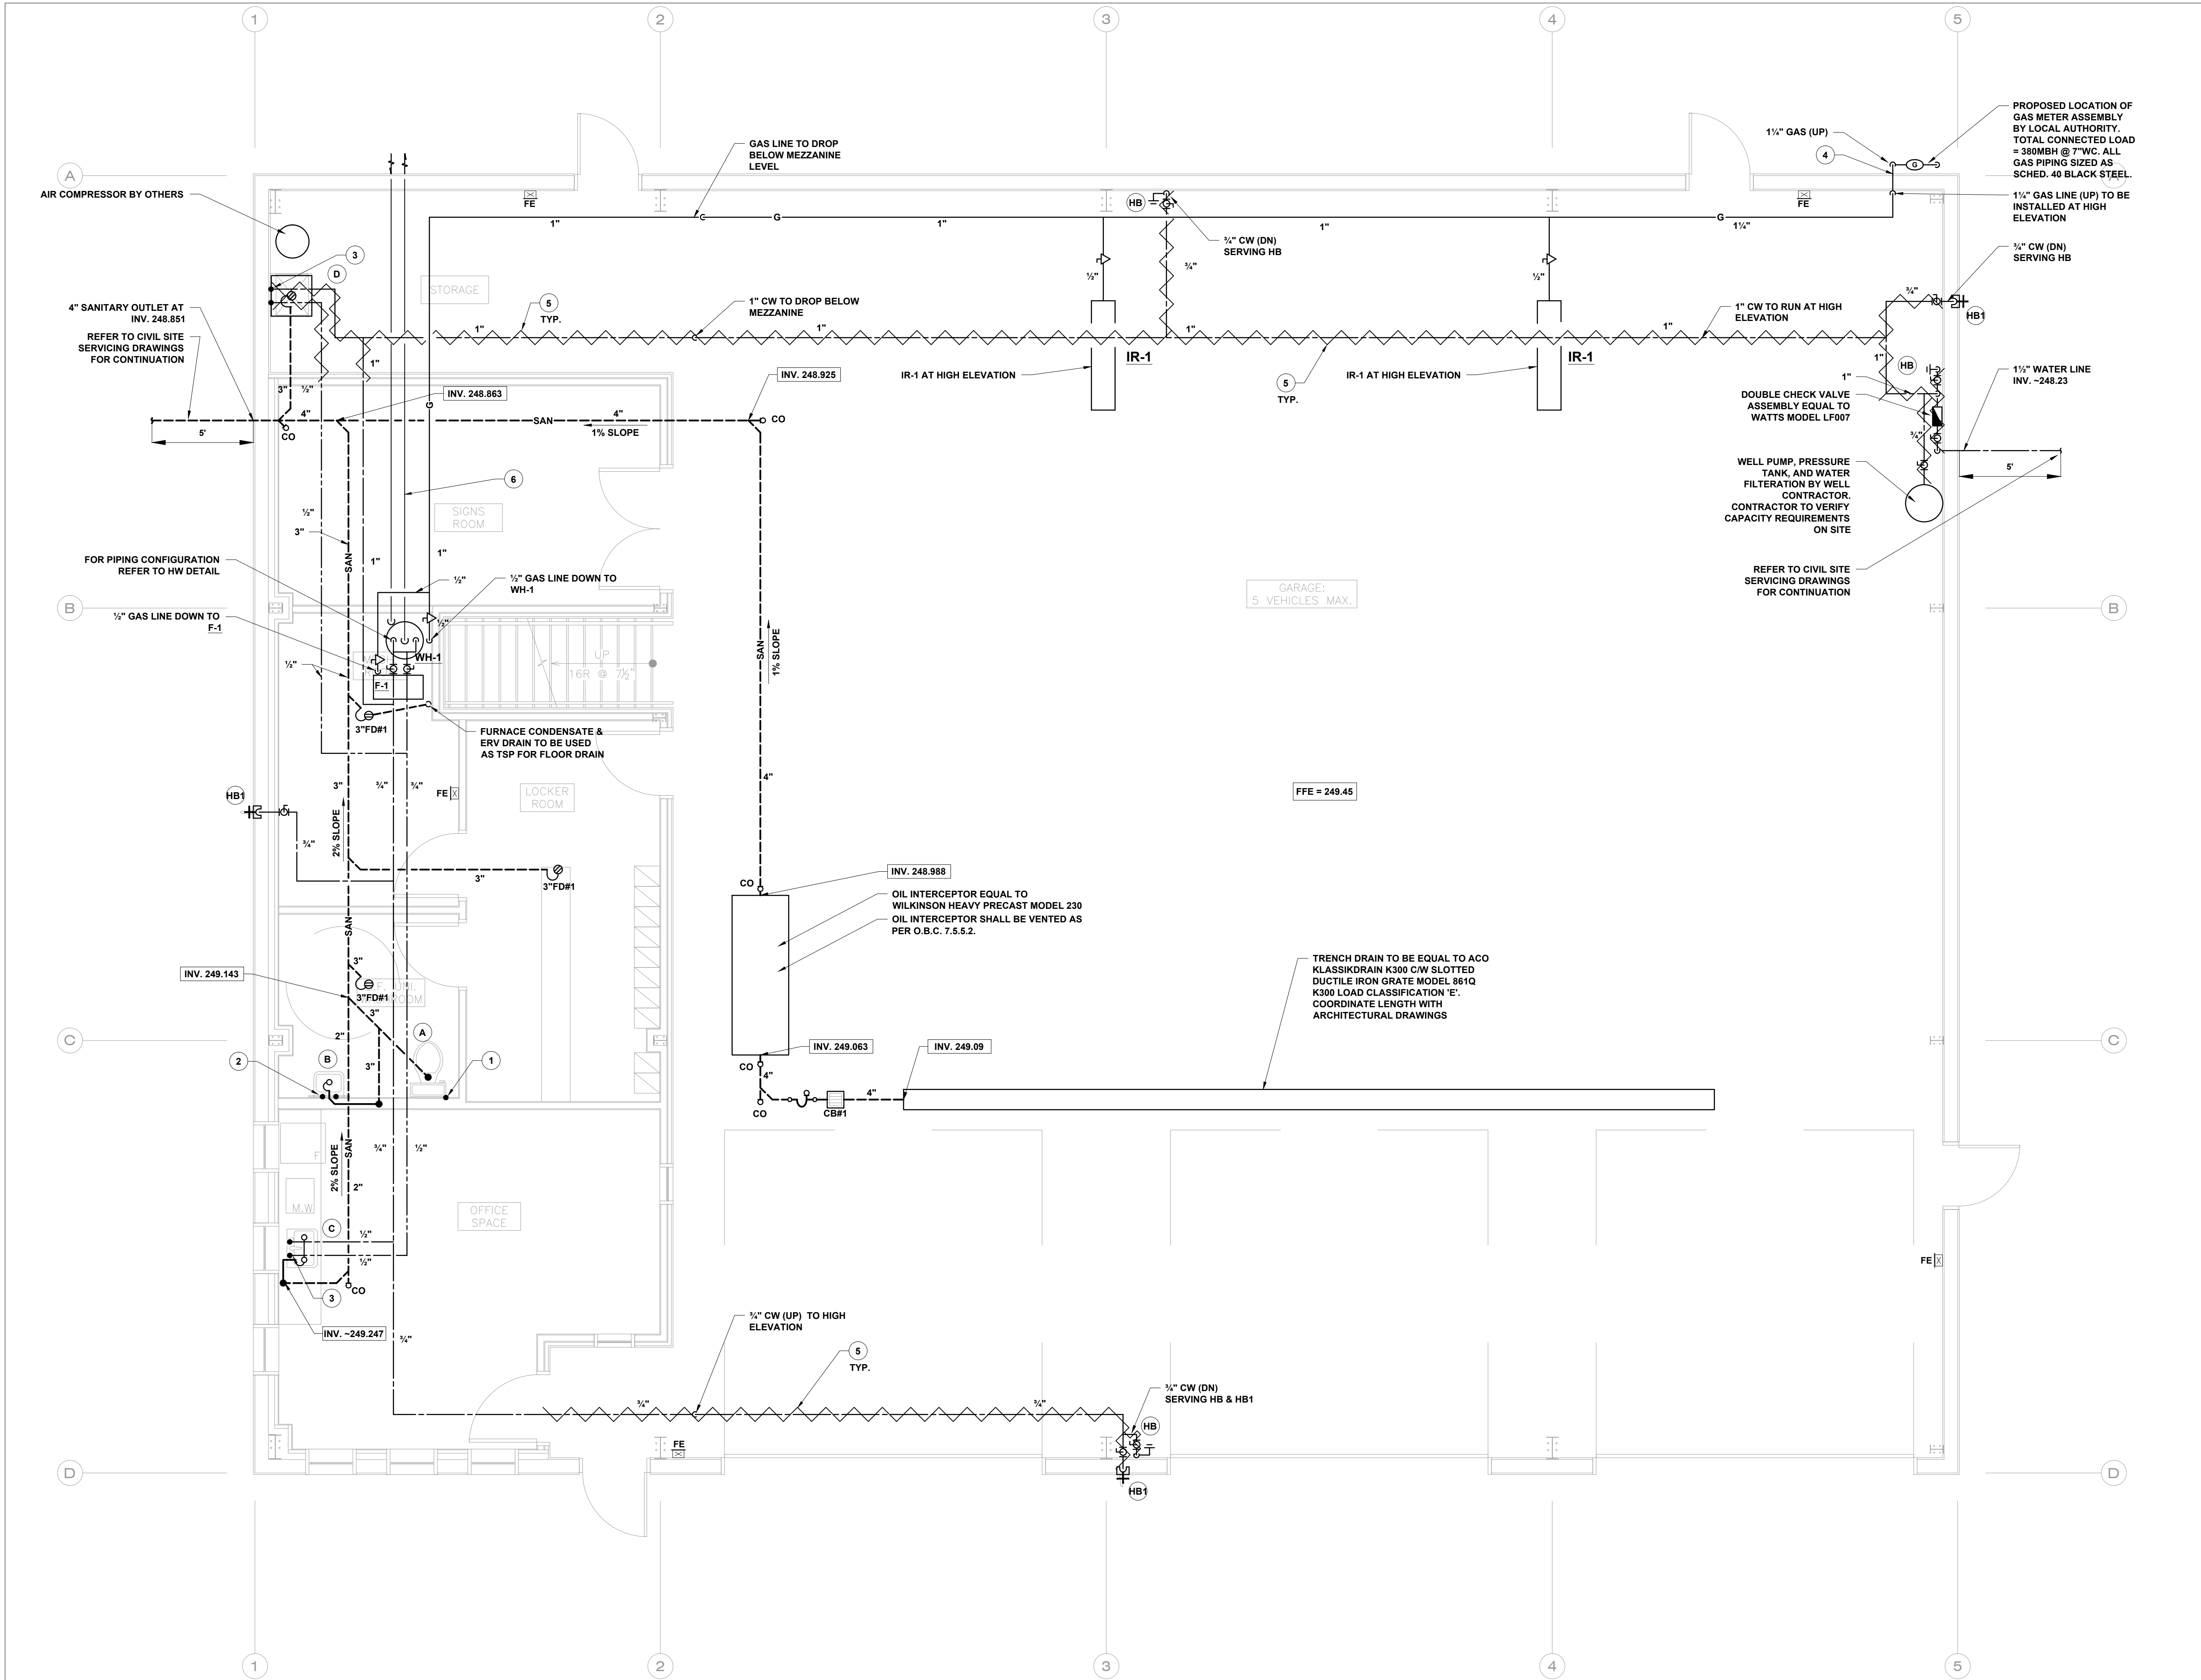

MAIN FLOOR PLAN
SCALE: 1/4" = 1' - 0"

DRAWING NOTES (DENOTED BY): #

- 1/2" COLD WATER TO WATER CLOSET.
- 1/4" DRAIN, 1/2" HOT & COLD WATER LINES SERVING LAV.
- 1/2" HOT & COLD WATER LINES SERVING SINK.
- GAS LINE ENTERING BUILDING SHALL MEET GAS CODE SECTION 6.15.8.
- ALL EXPOSED TRAPS & WET PIPING TO BE HEAT TRACED AND INSULATED, HEAT TRACE AND INSULATION BY MECHANICAL CONTRACTOR. CONNECTED BY ELECTRICAL CONTRACTOR. REFER TO DETAIL 1/M1.2.
- VENT & COMBUSTION PIPES SERVING WH-1 TO BE ULC S636 PVC TERMINATE THROUGH WALL. FOR VENT SIZING AND LENGTHS REFER TO HOT WATER HEATER MANUFACTURER INSTALLATION INSTRUCTIONS.


FIRE EXTINGUISHER SPECIFICATION

- PROVIDE ULC RATED 5LB. DRY CHEMICAL CLASS 2A:10B:C PORTABLE FIRE EXTINGUISHERS AS MANUFACTURED BY NFE C/W WALL MOUNTING BRACKET, IN ALL MECHANICAL ROOMS, ELECTRICAL ROOMS, GARBAGE ROOM AND WHERE INDICATED ON DRAWINGS AS PER ONTARIO FIRE CODE.

THE CONTRACTOR SHALL VERIFY ALL DIMENSIONS ON SITE. DO NOT SCALE DRAWINGS. DRAWINGS AND SPECIFICATIONS REMAIN THE PROPERTY OF THE ENGINEER AS INSTRUMENTS OF HIS SERVICE AND MUST BE RETURNED AT HIS REQUEST.

| No. | REVISION | DATE |
|-----|-------------------------|-----------|
| 2 | ISSUED FOR TENDER | SEPT 6'17 |
| 1 | ISSUED FOR OWNER REVIEW | AUG 25'17 |
| 0 | ISSUED FOR COORDINATION | AUG 18'17 |


MIDDLESEX COUNTY
399 RIDOUT STREET NORTH
LONDON, ON N6A 2P1

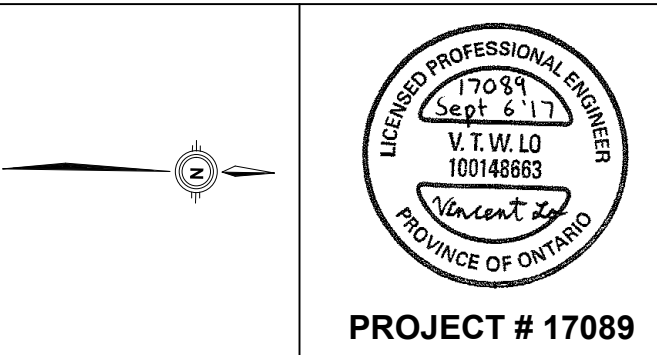

PUBLIC WORKS GARAGE
3550 EGREMONT DRIVE
STRATHROY ONTARIO

**MAIN FLOOR PLAN
-PLUMBING**


| | |
|-------------|-----------------------|
| DRAWN: TM | SCALE: 1/4" = 1' - 0" |
| DESIGN: TM | CHECKED: VL |
| DRAWING No. | REVISION: |
| M1.1 | R2 |

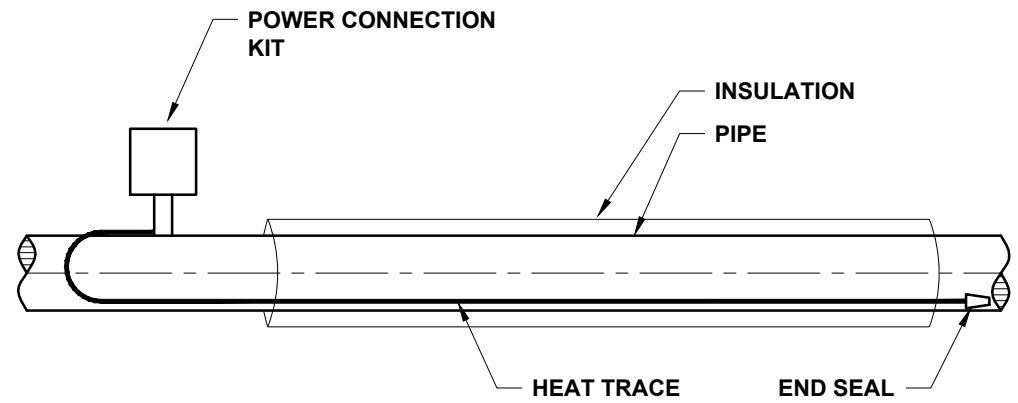

- NOTES:
- INCLUDE FOR ALL SPLICES, TEES, AND END SEALS REQUIRED.
 - MECHANICAL CONTRACTOR TO INSTALL CABLE AS PER MANUFACTURER INSTRUCTIONS.
 - MECHANICAL CONTRACTOR TO CONFIRM WITH THE HEAT TRACE MANUFACTURER THAT THE HEAT TRACE WATTAGE AND TYPE ARE APPLICABLE FOR USE WITH PIPE MATERIAL AND SIZE.
 - ACCEPTABLE MANUFACTURERS: BRITTECH, RAYCHEM, HEATLINE, OR THERMON.

1
M1.2

SELF-REGULATED HEAT TRACING
N.T.S.

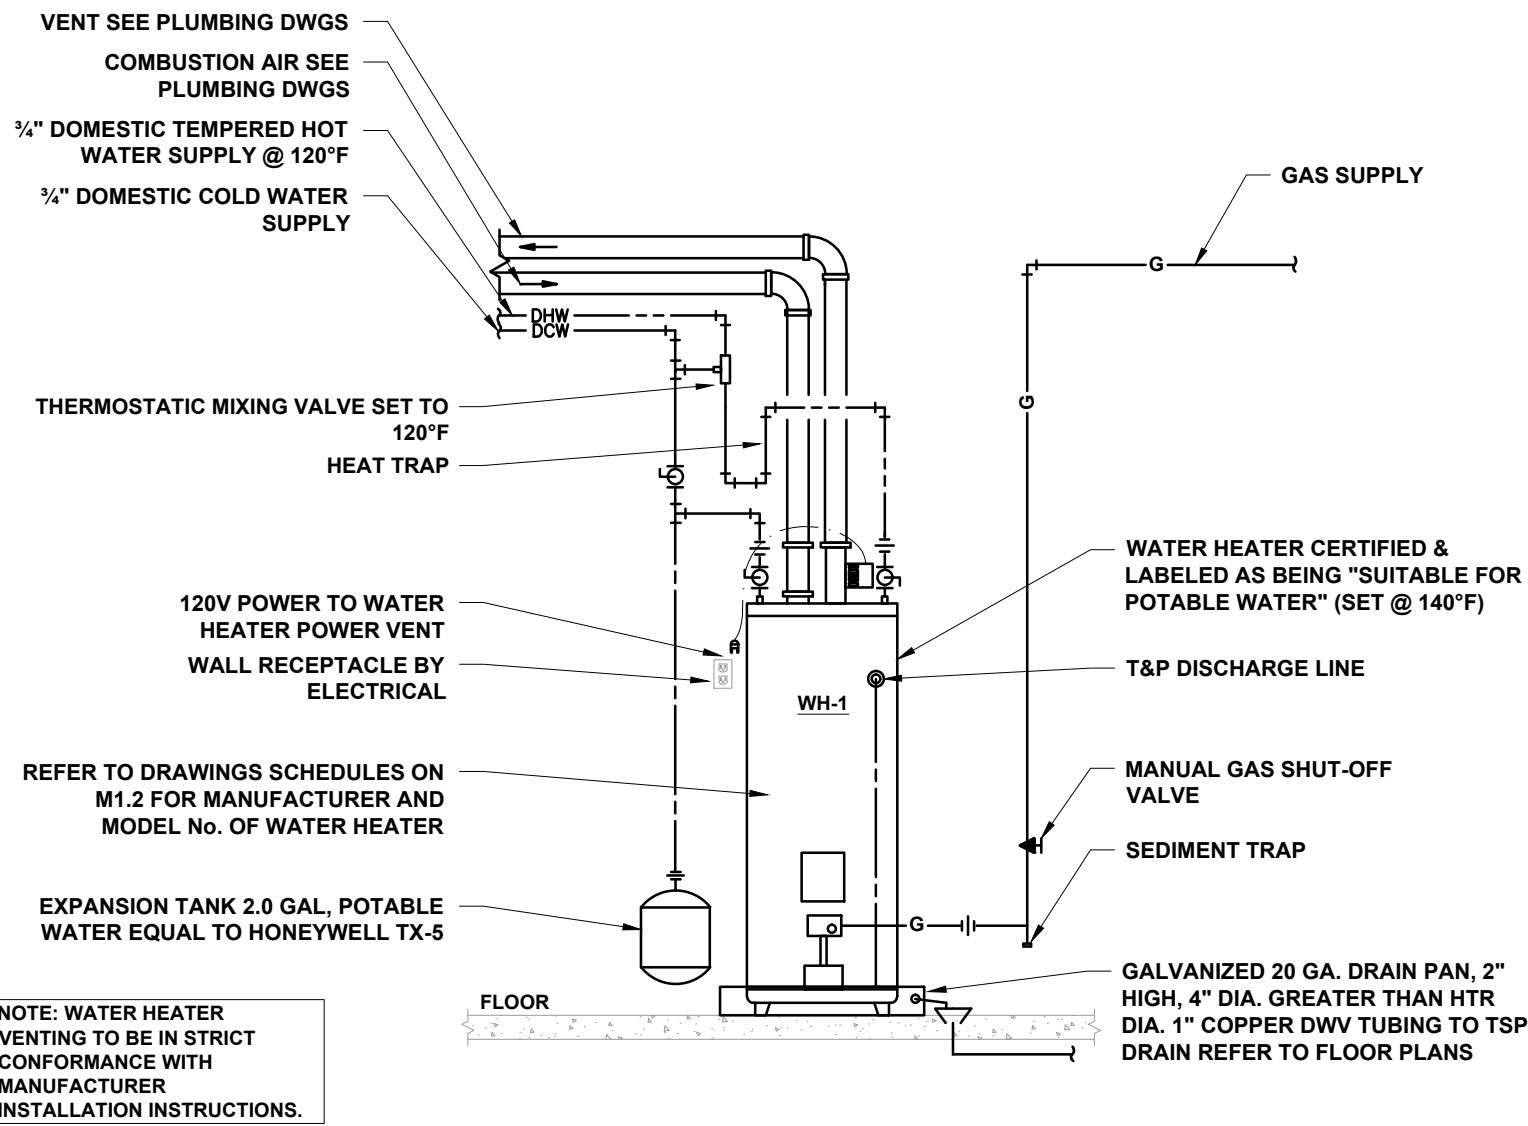

NOTE: WATER HEATER VENTING TO BE IN STRICT CONFORMANCE WITH MANUFACTURER INSTALLATION INSTRUCTIONS.

2
M1.2

WH-1 HEATER CONFIGURATION
N.T.S.

DRAINAGE NOTES:

- THERE SHALL BE A CLEANOUT INSTALLED AT THE BASE OF EACH SANITARY STACK.
- ALL DRAIN CONNECTIONS TO THE HORIZONTAL DRAIN AT BASE OF EACH STACK SHALL BE NOT LESS THAN 10'-0" FROM VERTICAL STACK.
- ALL VENT CONNECTIONS TO OTHER VENTS SHALL BE MADE ABOVE THE HIGHEST FLOOD LEVEL RIM OF FIXTURES SERVED.
- VTR SHALL INCREASE ONE PIPE SIZE, BUT NOT LESS THAN 3" IMMEDIATELY BEFORE IT PENETRATES THE ROOF.
- DRAINAGE WASTE AND VENT PIPING SHALL BE CAST IRON AND COPPER. PVC SYSTEM 15 IS ACCEPTABLE IF APPROVED BY THE OWNER AND JURISDICTION HAVING AUTHORITY FOR THE INTENDED APPLICATION.
- PVC SYSTEM 15 DRAINAGE EXPANSION SHALL BE ACCOMMODATED BY CSA CERTIFIED RUBBER COUPLINGS INSTALLED EVERY SECOND FLOOR FOR VERTICAL PIPE RUNS OR AT APPROPRIATE INTERVALS FOR LONG HORIZONTAL RUNS AS REQUIRED BY MANUFACTURER.
- PIPING AND FITTINGS LOCATED IN DROPPED CEILINGS OR POTENTIAL CONCEALED SPACES AS DESCRIBED IN O.B.C., 3.6.4.3.(1)(A) USED AS A RETURN AIR PLENUM TO BE PVC XFR, COPPER DWV, OR CAST IRON.
- COMBINATION OF COMBUSTIBLE AND NON-COMBUSTIBLE DRAINAGE PIPING WILL NOT BE ACCEPTED.

WATER PIPING NOTES:

- CPVC (AQUARISE) 1/2" - 4" PIPE SHALL BE ACCEPTED WITH THE FOLLOWING RESTRICTIONS. NO OTHER MANUFACTURERS OF CPVC ARE ACCEPTABLE.
 - CPVC PIPE ID MUST MEET THE MINIMUM ID'S OF IPS SIZED SDR 11 PIPE.
 - FOR 1-1/4" UP TO AND INCLUDING 4" PIPE SIZE:
 - NO SPACING RESTRICTIONS.
 - FOR 1/2" UP TO AND INCLUDING 1" FITTING SIZE:
 - FITTINGS AND VALVES MUST HAVE A MINIMUM SPACING OF 5-1/2" ALONG THE PIPE.
 - FITTINGS & VALVES ON ADJACENT PIPES WILL CONFORM TO LATERAL SPACING REQUIREMENTS ON THE PIPE.
 - VALVES 3/4" - 2" IN THE CPVC SYSTEM ARE TO BE CPVC (AQUARISE). 2-1/2" TO 4" PIPE SIZES SHALL USE CPVC FLANGES WITH BUTTERFLY VALVES.
 - INSTALLER SHALL DEBURR AND CHAMFER ENDS OF PIPE TO ENSURE PROPERLY GLUED CPVC CONNECTIONS.
 - INSTALLER SHALL NOT USE PIPE DOPE UNLESS OTHERWISE APPROVED BY CPVC MANUFACTURER.
 - INSTALLER SHALL CONSULT WITH THE CPVC PIPE MANUFACTURER PRIOR TO INSTALLATION FOR GUIDANCE WITH BUILDING CODE ISSUES, FIRESTOPPING, SUPPORT SPACING, ACCOMMODATION OF EXPANSION/CONTRACTION AND PROPER SOLVENT CEMENTING PROCEDURE.
 - PEX-A TUBING 1/2"-3" SHALL BE ACCEPTED WITH THE FOLLOWING RESTRICTIONS:
 - FOR 1/2" UP TO AND INCLUDING 2" TUBE SIZE:
 - PEX TUBING IN ALL CEILING SPACES AND BULKHEADS (PLENUM AND NON-PLENUM) OR EXPOSED SHALL BE INSTALLED WITH A MINIMUM SPACING OF 18" EXCEPT FOR THE FOLLOWING EXCEPTIONS:
 - UPONOR WIRSBO 1/2"-2" PEX - MIN. SPACING 0"
 - HEAT LINK 1/2" PEX - MIN. SPACING 8"
 - PEX-A TUBING 2-1/2" AND LARGER CAN ONLY BE USED IF CONCEALED WITHIN A WALL OR CONCRETE FLOOR SLAB, OR RATED INSULATION. RATED INSULATION MUST MEET SMOKE AND FLAME SPREAD RATINGS. REFER TO MANUFACTURER FOR REQUIREMENTS OF RATED INSULATION.
 - BALL VALVES ON 1/2" PEX TUBING TO BE FULL BORE DAHL 521LB-PRPX3-PRPX3 (PEX-F1960).
 - PEX & CPVC TUBING INSTALLED EXPOSED TO A UV LIGHT SOURCE (SUCH AS FLUORESCENT LIGHTS) MUST BE COVERED WITH INSULATION. REFER TO ELECTRICAL DRAWINGS.
 - COPPER PIPE ALL SIZES SHALL BE TYPE L COPPER.
 - COMBUSTIBLE PIPING IS NOT PERMITTED IN A VERTICAL SERVICE SPACE WHICH HAS A FIRE-RESISTANCE RATING OR FORMS A PART OF AN ASSEMBLY WHICH HAS A FIRE RESISTANCE RATING.
- GENERAL NOTES
- PLUMBING CONTRACTOR TO SUPPLY AND INSTALL ALL ACCESS DOORS (FIRE RATED AS REQUIRED) FOR ALL VALVE LOCATIONS INCLUDING SUITE VALVE LOCATIONS.
 - PROVIDE SHUT OFF VALVES AT ALL FINAL CONNECTIONS.
 - THE PLUMBING CONTRACTOR SHALL BE RESPONSIBLE FOR ALL PLUMBING OPENINGS THROUGH FIRE-WALLS, INCLUDING APPROPRIATE SLEEVES AND FIRE CAULKING.
 - THE PLUMBING CONTRACTOR IS RESPONSIBLE FOR ALL PIPE EXPANSION COMPENSATION REQUIREMENTS FOR EACH PIPE MATERIAL USED. CONSULT WITH THE PIPE MANUFACTURER'S RECOMMENDATIONS FOR DEVICES AND METHODS TO BE USED.
 - REFER TO SPECIFICATION SECTIONS FOR INSULATION.

PLUMBING FIXTURE SCHEDULE

| DRAWING REFERENCE | FIXTURE MAKE & MODEL | FIXTURE TRIM - MAKE & MODEL | CONNECTIONS | | | |
|-------------------|--|---|-------------|------|--------|--------|
| | | | HOT | COLD | DRAIN | VENT |
| A | WATER CLOSET AMER.STD. 2467.100 'CADET' PRESSURE ASSIST, WHITE, ELONGATED BOWL. 4.2 LPF | SEAT: CENTOCO 820STS (OPEN FRONT WITH COVER) SUPPLIES: MCGUIRE H166LKN3 FLOOR FLANGE, FLANGE BOLTS & NUTS | - | 1/2" | 3" | 1 1/4" |
| B | SUITE WALL HUNG LAVATORY AMER. STD. MURRO 0954.000 SEMI-PED 0059.020 | FITTING: MOEN CHATEAU L4601 - MAX FLOW AT 5.7 LPM TAILPIECE: MCGUIRE 155A CP OPEN GRID WITH 1 1/4" TAILPIECE TRAP: MCGUIRE 8872C SUPPLIES: MCGUIRE H165LKN3RB WASTE: CARRIER: SMITH 700-M31 | 1/2" | 1/2" | 1 1/4" | 1 1/4" |
| C | SINGLE STAINLESS STEEL SINK WITH LEDGE BACK - KINDRED QSL 2020-7 LEDGE BACK SINK WITH SPILLWAY, BRIGHT MIRROR FINISH | FITTING: MOEN CHATEAU 7445 - CHROME ONE HANDLE FAUCET - MAX FLOW AT 5.7 LPM TRAP: CAST BRASS 1-1/2", CLEANOUT, UNION ESCUTCH. SUPPLIES: ANGLE STOPS, ESCUTCH, METAL RISERS | 1/2" | 1/2" | 1 1/4" | 1 1/4" |
| D | JANITORS MOP RECEPTOR STERN WILLIAMS MTB-2424 | FITTING: AMERICAN STD. 8341.076.002 HERITAGE C/W T35 HOSE, T40 MOP HANGER,& 3" P-TRAP | 3/4" | 3/4" | 3" | 1 1/4" |
| HB | INTERIOR HOSEBIBB | FITTING: FITTING: WATTS HB-1 c/w INTEGRAL VACUUM BREAKER | - | 3/4" | - | - |
| HB1 | NON-FREEZE HOSEBIBB | FITTING: ZURN Z1315-VB c/w INTEGRAL VACUUM BREAKER | - | 3/4" | - | - |

NOTES:

- ALL SANITARY VENTING TO BE INSTALLED IN ACCORDANCE WITH THE LATEST EDITION OF ONTARIO BUILDING CODE.
- ALL FLOOR DRAINS TO BE TRAPPED, VENTED, AND PRIMED BELOW FLOOR.
- ALL TUB AND SHOWER SPOUTS SHALL BE SUPPORTED BY WING BACK 90°.

DRAIN SPECIFICATION

CB#1 DENOTES PARKING GARAGE CATCH BASIN EQUAL TO A WILKINSON HEAVY PRECAST GARAGE CATCH BASIN min CB120 COMPLETE WITH A CAST IRON GRATE. THE OUTSIDE DIMENSIONS OF THE CATCH BASIN ARE 585mm SQ. x 520mm DEEP.

FD#1 DENOTES FLOOR DRAIN EQUAL TO WATTS MODEL FD-100-C-3 (VANDAL PROOF) (ROUND) OR WATTS FD-100-C-3 (VANDAL PROOF) (SQUARE), CAST IRON BODY WITH ANCHOR FLANGE, POLISHED BRONZE 1/2" THICK STRAINER AND TSP TAPPING.

TRAP SEAL PRIMERS (NOT SHOWN ON DRAWINGS) TO BE INSTALLED ON COLD WATER SUPPLY PIPE OR A FIXTURE LOCAL TO THE DRAIN TRAP TO BE PRIMED. VACUUM BREAKER TO BE INTEGRAL TO THE PRIMER. TO BE INSTALLED AS PER PLUMBING CODE SECTION 7.4.5.5.

NOTE: PLUMBING CONTRACTOR TO CONFIRM CURRENT FLOOR / ROOF CONSTRUCTION AND COMPATIBILITY WITH MODEL NUMBER PRIOR TO ORDERING DRAINS.

MAX. FIXTURE FLOW RATES

| FIXTURE | MAXIMUM FLOWRATES (AS PER OBC 2012 TABLES 7.6.4.1. & 7.6.4.2.A.) |
|------------------------|--|
| LAVATORY FAUCET | 8.35 L/MIN (2.2 GPM) |
| KITCHEN FAUCET | 8.35 L/MIN (2.2 GPM) |
| TANK TYPE WATER CLOSET | 6 L / FLUSH (1.6 GPF) |

NOTE: ENSURE THAT ALL FIXTURES ADHERE TO FIXTURE FLOW RATE SCHEDULE

GAS FIRED WATER HEATER SCHEDULE

| DRAWING REFERENCE | SERVICE | MANUFACTURER | MODEL | INPUT [MBH] | OUTPUT [MBH] | STORAGE CAPACITY [U.S.G] | RECOVERY 50°F-140°F [GPH] | DIMENSIONS | | | NOTES |
|-------------------|--------------------|----------------|-------------|-------------|--------------|--------------------------|---------------------------|------------|-------------|-----------------------|-------|
| | | | | | | | | WIDTH [IN] | HEIGHT [IN] | SHIPPING WEIGHT [LBS] | |
| WH-1 | DOMESTIC HOT WATER | BRADFORD WHITE | RQ2PDV40S6N | 40 | - | 40 | 38 | 30.5 | 60 | 161 | |


NOTES:

- PROVIDE 3" CONCENTRIC VENT

THE CONTRACTOR SHALL VERIFY ALL DIMENSIONS ON SITE. DO NOT SCALE DRAWINGS. DRAWINGS AND SPECIFICATIONS REMAIN THE PROPERTY OF THE ENGINEER AS INSTRUMENTS OF HIS SERVICE AND MUST BE RETURNED AT HIS REQUEST.

| 2 | ISSUED FOR TENDER | SEPT 6'17 |
|-----|-------------------------|-----------|
| 1 | ISSUED FOR OWNER REVIEW | AUG 25'17 |
| 0 | ISSUED FOR COORDINATION | AUG 18'17 |
| No. | REVISION | DATE |

MIDDLESEX COUNTY
399 RIDOUT STREET NORTH
LONDON, ON N6A 2P1

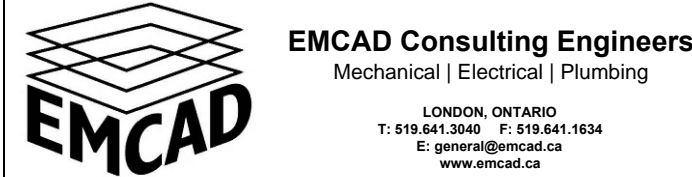


PROJECT # 17089

PUBLIC WORKS GARAGE
3550 EGREMONT DRIVE


STRATHROY ONTARIO

SCHEDULES & DETAILS
-PLUMBING

| | |
|-------------|---------------|
| DRAWN: TM | SCALE: N.T.S. |
| DESIGN: TM | CHECKED: VL |
| DRAWING No. | REVISION: |
| M1.2 | R2 |

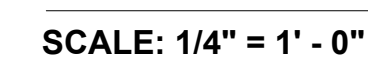

- | | |
|------------------------|------------------------------|
| DRAWN: VL | SCALE: 1/4" = 1' - 0" |
| DESIGN: VL | CHECKED: VL |
| DRAWING No. | REVISION: |
| M2.1 | R2 |

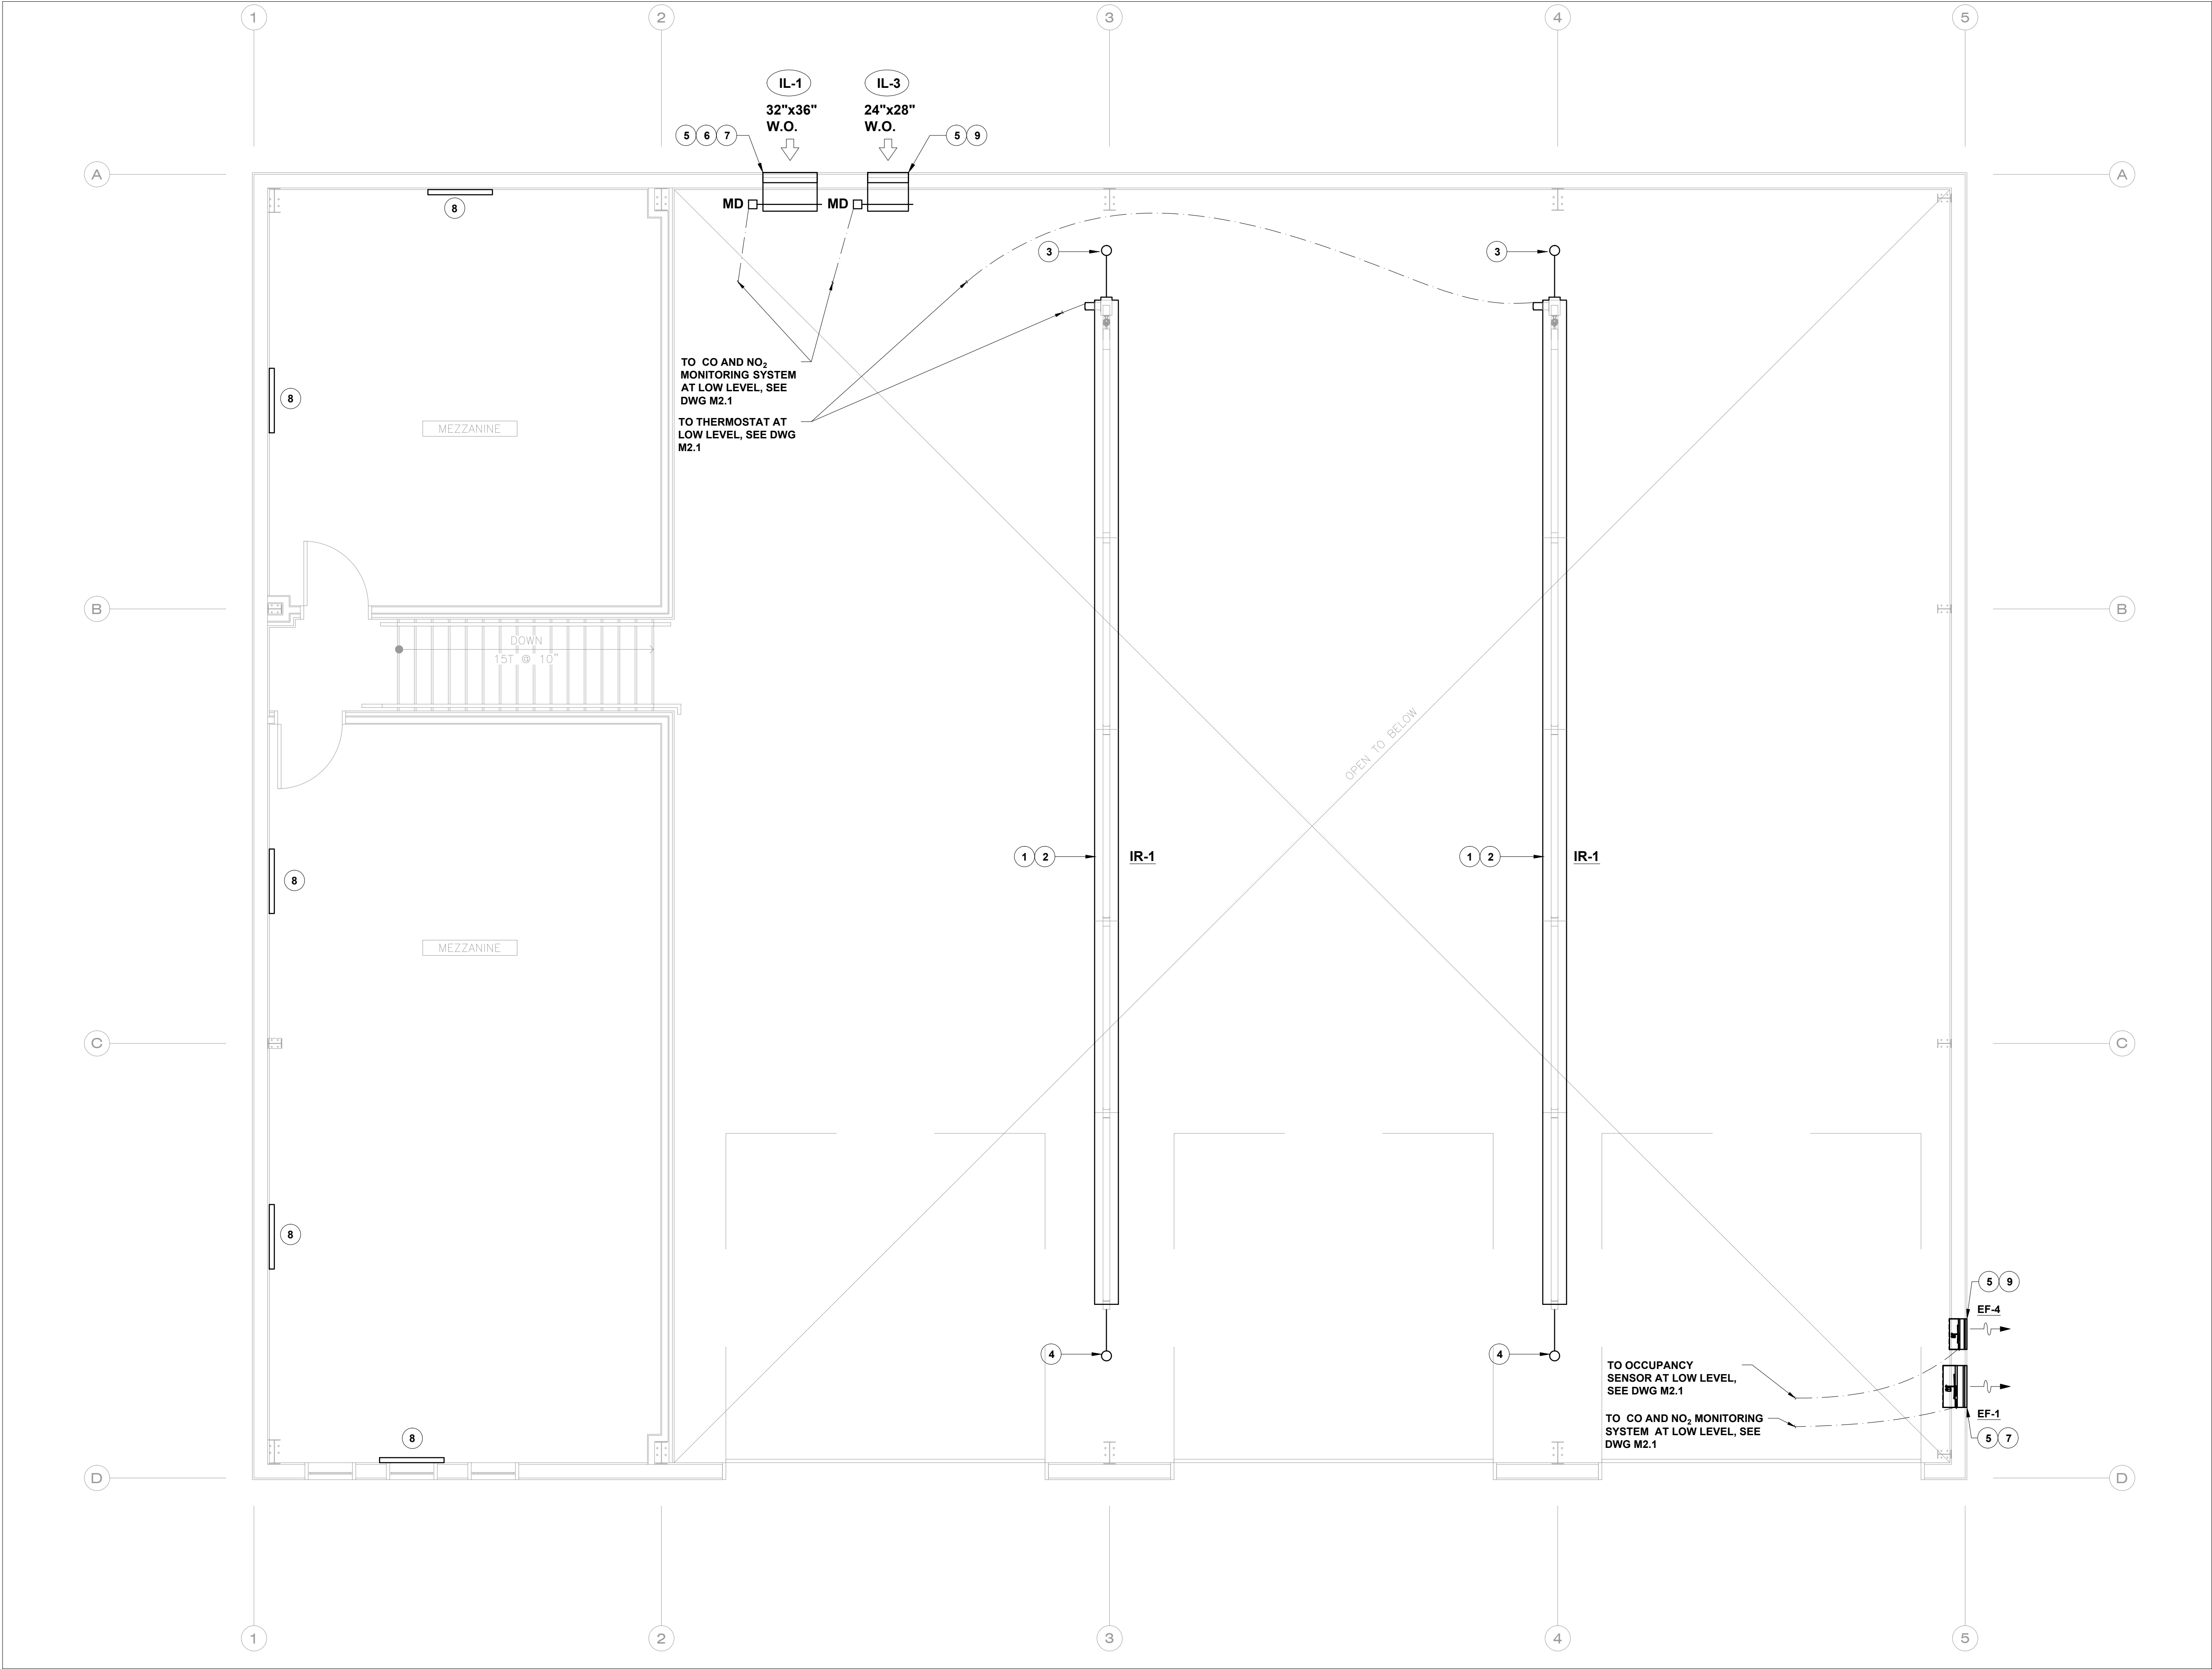


SECOND FLOOR PLAN
SCALE: 1/4" = 1' - 0"

- GENERAL NOTES:
- THESE DRAWINGS ARE TO BE USED IN CONJUNCTION WITH THE ARCHITECTURAL REFLECTIVE CEILING PLANS AND STRUCTURAL DRAWINGS.
- EQUIPMENT NOTES (DENOTED BY): #
- PROVIDE NEW GAS FIRED RADIANT TUBE HEATER, WIND AND RAIN HOOD, THERMOSTAT, PROVIDE STEEL HANGER KIT. INSTALL INFRARED HEATING ELEMENTS AS PER MANUFACTURERS RECOMMENDATIONS.
 - COORDINATE INSTALLATION OF HEATERS WITH LIGHTING. SEE ELECTRICAL DRAWINGS FOR LOCATIONS AND HEIGHTS.
 - 4" COMBUSTION AIR UP THROUGH ROOF. TERMINATE WITH VENT CAP AS PER MANUFACTURER RECOMMENDATIONS.
 - 4" VENT TERMINATION THROUGH ROOF. TERMINATE WITH VENT CAP AS PER MANUFACTURER RECOMMENDATIONS.
 - ALL EXTERIOR LOUVRES AND GRILLES ARE TO BE PAINTED BY THE MANUFACTURER. OBTAIN COLOUR CHIP FROM ARCHITECT. (TYPICAL FOR ALL)
 - PROVIDE NEW SIDEWALL LOUVRE C/W MOTORIZED DAMPER WITH ACTUATOR INTERLOCKED WITH EXHAUST FAN EF-1. EXACT MOUNTING HEIGHT AND LOCATION TO BE CONFIRMED ON SITE.
 - MECHANICAL CONTRACTOR TO PROVIDE CO AND NO₂ MONITORING SENSOR. ELECTRICAL CONTRACTOR 120V WIRING AND POWER CONNECTIONS FROM CO AND NO₂ MONITORING SYSTEM TO MOTORIZED DAMPERS ON IL-1, AND EXHAUST FAN EF-1.
 - ELECTRICAL CONTRACTOR TO PROVIDE 0.75 KW ELECTRIC BASEBOARD HEATER COMPLETE WITH BUILT-IN THERMOSTAT.
 - PROVIDE NEW SIDEWALL LOUVRE C/W MOTORIZED DAMPER WITH ACTUATOR INTERLOCKED WITH EXHAUST FAN EF-4. EXACT MOUNTING HEIGHT AND LOCATION TO BE CONFIRMED ON SITE.


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
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| No. | REVISION | DATE |

MIDDLESEX COUNTY
399 RIDOUT STREET NORTH
LONDON, ON N6A 2P1

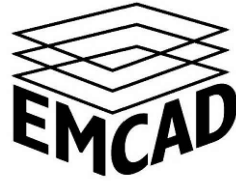

EMCAD Consulting Engineers
Mechanical | Electrical | Plumbing
LONDON, ONTARIO
T: 519.841.2000 F: 519.841.1634
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www.emcad.ca





PROJECT # 17089

PUBLIC WORKS GARAGE
3550 EGREMONT DRIVE
STRATHROY ONTARIO

SECOND FLOOR PLAN
-HVAC

| | |
|-------------|-----------------------|
| DRAWN: VL | SCALE: 1/4" = 1' - 0" |
| DESIGN: VL | CHECKED: VL |
| DRAWING No. | REVISION: |
| M2.2 | R2 |

| CONDENSING UNIT SCHEDULE | | | | | | | | | | | | | |
|--|---------|--------------|--------------|----------------------|-------------------------|------------|------|--------------------|-----------------|------------|------|------|--------------------|
| DRAWING REFERENCE | SERVICE | MANUFACTURER | MODEL | COOLING | | | | REFRIGERANT TUBING | | ELECTRICAL | | | SOUND RATINGS [DB] |
| | | | | TOTAL CAPACITY [MBH] | SENSIBLE CAPACITY [MBH] | O.A.T [°F] | SEER | VAPOUR [IN. OD] | LIQUID [IN. OD] | V/Ph/Hz | RLA | MCA | MOCP |
| CU-1 | F-1 | CARRIER | 24ACC524A003 | 23.4 | 18.6 | 95.0 | 14.0 | 3/4" | 3/8" | 208/1/60 | 10.9 | 14.1 | 20.0 |
| NOTES: | | | | | | | | | | | | | |
| 1. SEE SPECIFICATIONS FOR ACCEPTABLE MANUFACTURERS | | | | | | | | | | | | | |
| 2. FOR TUBING SETS LONGER THAN 40FT (EQUIVALENT LENGHT), REFER TO THE MANUFACTURER'S GUIDELINES FOR REQUIRED TUBING SIZES, INSULATION THICKNESS AND ACCESSORIES. | | | | | | | | | | | | | |
| 3. ALL UNITS C/W R-410A REFRIGERANT | | | | | | | | | | | | | |

| ENERGY / HEAT RECOVERY VENTILATING UNIT SCHEDULE | | | | | | | | | | | | |
|--|---------|--------------|--------------|---------------------------|---------|---------------------|-------------|---|--------------|----------|-------------------|--|
| DRAWING REFERENCE | SERVICE | MANUFACTURER | MODEL | PRESSURE DROP [IN.WG.] | | AIR VOLUME [CFM] | | SENSIBLE RECOVERY EFFICIENCY [HEATING] | ELECTRICAL | | WEIGHT T [LBS] | REMARKS |
| | | | | SUPPLY | EXHAUST | SUP PLY | EXHA UST | | V/Ph/H z | AMP S | | |
| ERV-1 | OFFICE | VENMAR | X24ERV ECM-N | 0.3 | 0.3 | 220 | 220 | MINIMUM 61% AT 0°C/32°F | 115/1/6 0 | 2.0 | 26 | - C/W TIMER SWITCH PROVIDED BY MECHANICAL CONTRACTOR WIRED BY ELECTRICAL CONTRACTOR - FANS TO RUN CONTINUOUS AT LOW SPEED AND UPON ACTIVATION OF TIMER FAN OR FURNACE TO RUN AT HIGH SPEED |
| NOTES: | | | | | | | | | | | | |
| 1. SEE SPECIFICATIONS FOR ACCEPTABLE MANUFACTURERS | | | | | | | | | | | | |

| INFRARED HEATING UNITS | | | | | | | | | | | |
|---|---------|---------------------------------|--------|-----------------|----------------------------|----------------|-----------------------|--------------|-----------------------------------|-------------------------|------------------------------------|
| DRAWING REFERENC E | SERVICE | MANUFACTURER | MODEL | LENGTH [FT.] | INPUT CAPACITY [MBH] | FUEL | GAS CONNECT ION | VENT SIZE | GAS INLET PRESSURE [IN.WG.] | ELECTRICAL [V/PH/HZ] | REMARKS |
| IR-1 | GARAGE | SUPERIOR RADIANT PRODUCTS | AM-150 | 50'-0" | 90 - 150 | NATURAL GAS | 1/2" NPT | 4" | 5.3-14.0 | 120/1/60 | - C/W MODULATING THERMOSAT, 24V |
| NOTES: | | | | | | | | | | | |
| 1. ALL INFRARED HEATERS TO BE MODULATING | | | | | | | | | | | |
| 2. PROVIDE THERMOSTATS AND CONTROL PANEL AS SHOWN ON DRAWINGS | | | | | | | | | | | |


| WALLBOX & LOUVRE SCHEDULE | | | | | | |
|--|--------------|--------|-----|---------|------------|--------------------|
| DRAWING REFERENCE | MANUFACTURER | MODEL | NO. | TYPE | SIZE [LxW] | REMARKS |
| (WB-1) | REVERSOMATIC | SWBL-8 | | EXHAUST | 8"x8" | SINGLE WALL BOX |
| (WB-2) | REVERSOMATIC | DWBL-8 | | EXHAUST | 16"x8" | DOUBLE WALL BOX |
| (IL-1) | VENTEX | 2435 | | INTAKE | 32"x36" | 4" DEEP, DRAINABLE |
| (IL-2) | VENTEX | 2435 | | INTAKE | 16"x16" | 4" DEEP, DRAINABLE |
| (IL-3) | VENTEX | 2435 | | INTAKE | 24"x28" | 4" DEEP, DRAINABLE |
| NOTES: SEE SPECIFICATIONS FOR ACCEPTABLE MANUFACTURERS | | | | | | |

| MECHANICAL LEGEND | | | | | | | |
|--|--------------------------------------|--------|---|--------|---|--------|--|
| SYMBOL | DESCRIPTION | SYMBOL | DESCRIPTION | SYMBOL | DESCRIPTION | SYMBOL | DESCRIPTION |
| —CWS— | CHILLED WATER SUPPLY PIPING | | IN-LINE PUMP | | EXISTING DUCTWORK - SINGLE LINE | | GRILLE REFERENCE (SEE GRILLE AND DIFF. SCHED. FOR MODEL AND SIZE) |
| —CWR— | CHILLED WATER RETURN PIPING | | GAS METER | | NEW DUCTWORK - SINGLE LINE | | AIR CAPACITY [CFM] |
| —HWS— | HEATING SUPPLY PIPING | | WATER METER | | DUCTWORK TO BE REMOVED - SINGLE LINE | | WALL BOX OR LOUVRE REFERENCE (SEE GRILLE AND DIFF. SCHED. FOR MODEL AND SIZE) |
| —HWR— | HEATING RETURN PIPING | | AUTO AIR VENT | | NEW DUCTWORK - DOUBLE LINE | | HEATING RISER # |
| —HPS— | HEAT PUMP SUPPLY PIPING | | MANUAL AIR VENT | | EXISTING DUCTWORK - DOUBLE LINE DUCTWORK TO REMAIN | | CONDENSATE RISER # |
| —HPR— | HEAT PUMP RETURN PIPING | | DRAIN | | EXISTING DUCTWORK - DOUBLE LINE DUCTWORK TO BE REMOVED | | MAKE-UP AIR RISER # |
| —LIQ— | LIQUID REFRIGERATION LINE | | CAP | | EXTERNALLY INSULATED DUCTWORK | | DRAWING NOTES |
| —SUC— | SUCTION REFRIGERATION LINE | | WELL | | INTERNALLY INSULATED DUCTWORK | | NEW DIFFUSER NOTES |
| —STM— | STEAM PIPING | | F.S. | | FIRE DAMPER | | SQUARE CONE DIFFUSER (ROUND IF SHOWN) DUCT COLLAR CONNECTION SIZE AS PER GRILLE AND DIFFUSER SCHEDULE |
| —COND— | CONDENSATE PIPING | | TEMPERATURE GAUGE | | MOTORIZED DAMPER | | FLEXIBLE DUCT - MAX. 6'-0" (1.8M) |
| | EXISTING SUPPLY PIPING TO BE REMOVED | | PRESSURE GAUGE | | BALANCING DAMPER | | DIFFUSER SUPPLY DUCT - TO BE THE SAME SIZE AS DIFFUSER COLLAR |
| | EXISTING RETURN PIPING TO BE REMOVED | | THERMOSTAT | | BACK DRAFT DAMPER | | BALANCE DAMPER - TYPICAL AT ALL DIFFUSER SUPPLIES |
| —SAN— | SANITARY PIPING | | HUMIDISTAT | | SPLITTER DAMPER | | SUPPLY DUCT |
| ---SAN--- | SANITARY PIPING (BURIED) | | SENSOR | | FAN SPEED CONTROLLER | | |
| —ST— | STORM PIPING | | SENSOR | | NEW CONNECTION TO EXISTING DUCTS | | |
| ---ST--- | STORM PIPING (BURIED) | | D.C.V.A. REDUCED PRESSURE PRINCIPLE | | NEW SUPPLY AIR GRILLE | | |
| — | DOMESTIC COLD WATER PIPING | | HOSE BIB | | NEW RETURN AIR GRILLE | | |
| — | DOMESTIC HOT WATER PIPING | | NON-FREEZE HOSE BIB | | EXISTING SUPPLY AIR GRILLE TO REMAIN RELOCATE AS INDICATED TO SUIT LAYOUT | | |
| — | DOMESTIC HOT WATER RECIRC PIPING | | FLOOR CLEAN OUT | | EXISTING RETURN AIR GRILLE TO REMAIN RELOCATE AS INDICATED TO SUIT LAYOUT | | |
| — | VENT PIPING | | AREA CLEAN OUT | | EX. SUPPLY AIR GRILLE TO BE REMOVED | | |
| —G— | GAS PIPING | | RUNNING TRAP c/w HANDHOLES ON EACH SIDE | | EX. RETURN AIR GRILLE TO BE REMOVED | | |
| —EG— | EMERGENCY GAS PIPING | | SCUPPER DRAIN | | SIDEWALL GRILLE C/W BALANCE DAMPER TYPICAL AT ALL SIDEWALL GRILLES | | |
| | ISOLATION VALVE | | VENT THROUGH ROOF | | | | |
| | BALANCING/ISOLATION VALVE | | FIRE EXTINGUISHER | | | | |
| | TRIPLE DUTY VALVE | | FROM ABOVE | | | | |
| | GATE VALVE | | FROM BELOW | | | | |
| | BALL VALVE | | DOWN | | | | |
| | BUTTERFLY VALVE | | UP | | | | |
| | GLOBE VALVE | | HIGH PRESSURE / LOW PRESSURE | | | | |
| | 2-WAY CONTROL VALVE | | | | | | |
| | 3-WAY CONTROL VALVE | | | | | | |
| | CHECK VALVE | | | | | | |
| | FLEXIBLE CONNECTOR | | | | | | |
| | BACKFLOW PREVENTER | | | | | | |
| | PRESSURE REDUCING VALVE | | | | | | |
| | CIRCUIT SETTER VALVE | | | | | | |
| | GAS COCK (SHUT OFF VALVE) | | | | | | |
| | TEMPERATURE & PRESSURE RELIEF VALVE | | | | | | |
| | STRAINER | | | | | | |
| | UNION | | | | | | |
| THIS IS A STANDARD LEGEND. ALL TAGS MAY NOT NECESSARILY BE USED ON DRAWINGS. | | | | | | | |


| FURNACE SCHEDULE | | | | | | | | | | | | | | |
|--|---------|--------------|-----------------|-------------------|--|----------------|----------------|-----------------|------------|-----|------|-------------|------|---|
| DRAWING REFERENCE | SERVICE | MANUFACTURER | MODEL | AIR FLOW [CFM] | EXTERNAL STATIC PRESSURE [IN.WC.] | FUEL | INPUT [MBH] | OUTPUT [MBH] | ELECTRICAL | | | CONNECTIONS | | REMARKS |
| | | | | | | | | | V/P/H | MCA | MOP | GAS | VENT | |
| F-1 | OFFICE | CARRIER | 59SC5A040S14-10 | 800 | 0.1 | NATURAL GAS | 40.0 | 39.0 | 115/1/60 | 6.8 | 15.0 | 3/4 | 6 | SUPPLIED WITH A 24V 7-DAY PROGRAMMABLE THERMOSTAT AND A SIDE FILTER RACK. FURNACE TO BE UPFLOW SUPPLY, SIDE RETURN. |
| NOTES: SEE SPECIFICATIONS FOR ACCEPTABLE MANUFACTURERS | | | | | | | | | | | | | | |

| FAN SCHEDULE | | | | | | | | | | | | | |
|--|-----------------------------|---|--------------|--------------------|----------------|-----------------------------------|---|----------|----------|-----|--|----------|---|
| DRAWING REFERENCE | SERVICE | MANUFACTURER | MODEL | TYPE | AIR FLOW [CFM] | EXTERNAL STATIC PRESSURE [IN.WG.] | FAN RPM | MOTOR | | | ACCESSORIES | MOUNTING | REMARKS |
| | | | | | | | | MOTOR HP | V/PH/Hz | RPM | | | |
| EF-1 | GARAGE EXHAUST FAN | GREENHECK | SBE-1L20-4 | SIDEWALL PROPELLER | 3325.0 | 0.125 | - | 0.25 | 120/1/60 | 810 | 9,12,14,17 | WALL | C/W WALL HOUSING MOUNTING AND ASSOCIATED ACCESSORIES, INTERLOCKED WITH INTAKE MOTORIZED DAMPERS, CONTROLLED BY CO AND NO ₂ MONITORING SENSOR |
| EF-2 | WASHROOM EXHAUST FAN | BROAN | DX-110 | CEILING CABINET | 100.0 | 0.2 | - | FHP | 120/1/60 | - | 1,2,5 | CEILING | CONTROLLED BY LIGHT SWITCH/OCCUPANCY SENSOR |
| EF-3 | MECHANICAL ROOM EXHAUST FAN | GREENHECK | SP-A200 | CEILING CABINET | 224.0 | 0.25 | - | FHP | 120/1/60 | - | 1,2,5 | CEILING | CONTROLLED BY REVERSE-ACTING THERMOSTAT, INTERLOCKED WITH INTAKE MOTORIZED DAMPER, PROVIDE OVERRIDE SWITCH |
| EF-4 | WORKSHOP EXHAUST FAN | GREENHECK | SE1-12-426-D | SIDEWALL PROPELLER | 930.0 | 0.125 | - | 0.1 | 120/1/60 | - | 12,17 | WALL | C/W WALL HOUSING MOUNTING AND ASSOCIATED ACCESSORIES, INTERLOCKED WITH INTAKE MOTORIZED DAMPERS, CONTROLLED BY OCCUPANCY SENSOR |
| ACCESSORIES: | | | | | | | | | | | | | |
| 1. HANGER RODS | | 6. INDICATE ROOF CURB TO BE PROVIDED BY GENERAL CONTRACTOR AS DETAILED ON ARCHITECTURAL DWGS. | | | | | 11. TRANSFORMER AND RELAY FOR 24V CONTROL | | | | 16. DRAIN CONNECTION | | |
| 2. HANGING VIBRATION ISOLATORS | | 7. ROOF CURB BY FAN MANUFACTURER | | | | | 12. WEATHER HOOD | | | | 17. MATCHING EXT. WALL LOUVRE W/ BIRDSCREEN AND B.D.D. | | |
| 3. BASE ISOLATOR KIT | | 8. DISCONNECT SWITCH | | | | | 13. WALL MOUNT COLLAR | | | | 18. SOLID STATE SPEED CONTROL (MOUNTED IN FAN HOUSING) BELT DRIVE MOTOR COVERS | | |
| 4. FLEXIBLE CONNECTIONS - INLET AND OUTLET | | 9. BELTS, DRIVES AND PULLEYS | | | | | 14. BELT DRIVE MOTOR COVERS | | | | 19. CONTROL PANEL | | |
| 5. BACKDRAFT DAMPER | | 10. ACCESS DOOR | | | | | 15. INSULATED HOUSING | | | | | | |

| | | |
|---|-------------------------|---------------|
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| No. | REVISION | DATE |
| MIDDLESEX COUNTY | | |
| 399 RIDOUT STREET NORTH | | |
| LONDON, ON N6A 2P1 | | |
| EMCAD Consulting Engineers Mechanical Electrical Plumbing LONDON, ONTARIO T: 519.841.3300 F: 519.841.1434 E: general@emcad.ca www.emcad.ca | | |
| PROJECT # 17089 | | |
| PUBLIC WORKS GARAGE 3550 EGREMONT DRIVE | | |
| STRATHROY ONTARIO | | |
| SCHEDULES & DETAILS -HVAC | | |
| DRAWN: VL | | SCALE: N.T.S. |
| DESIGN: VL | | CHECKED: VL |
| DRAWING No. | | REVISION: |
| M2.3 | | R2 |

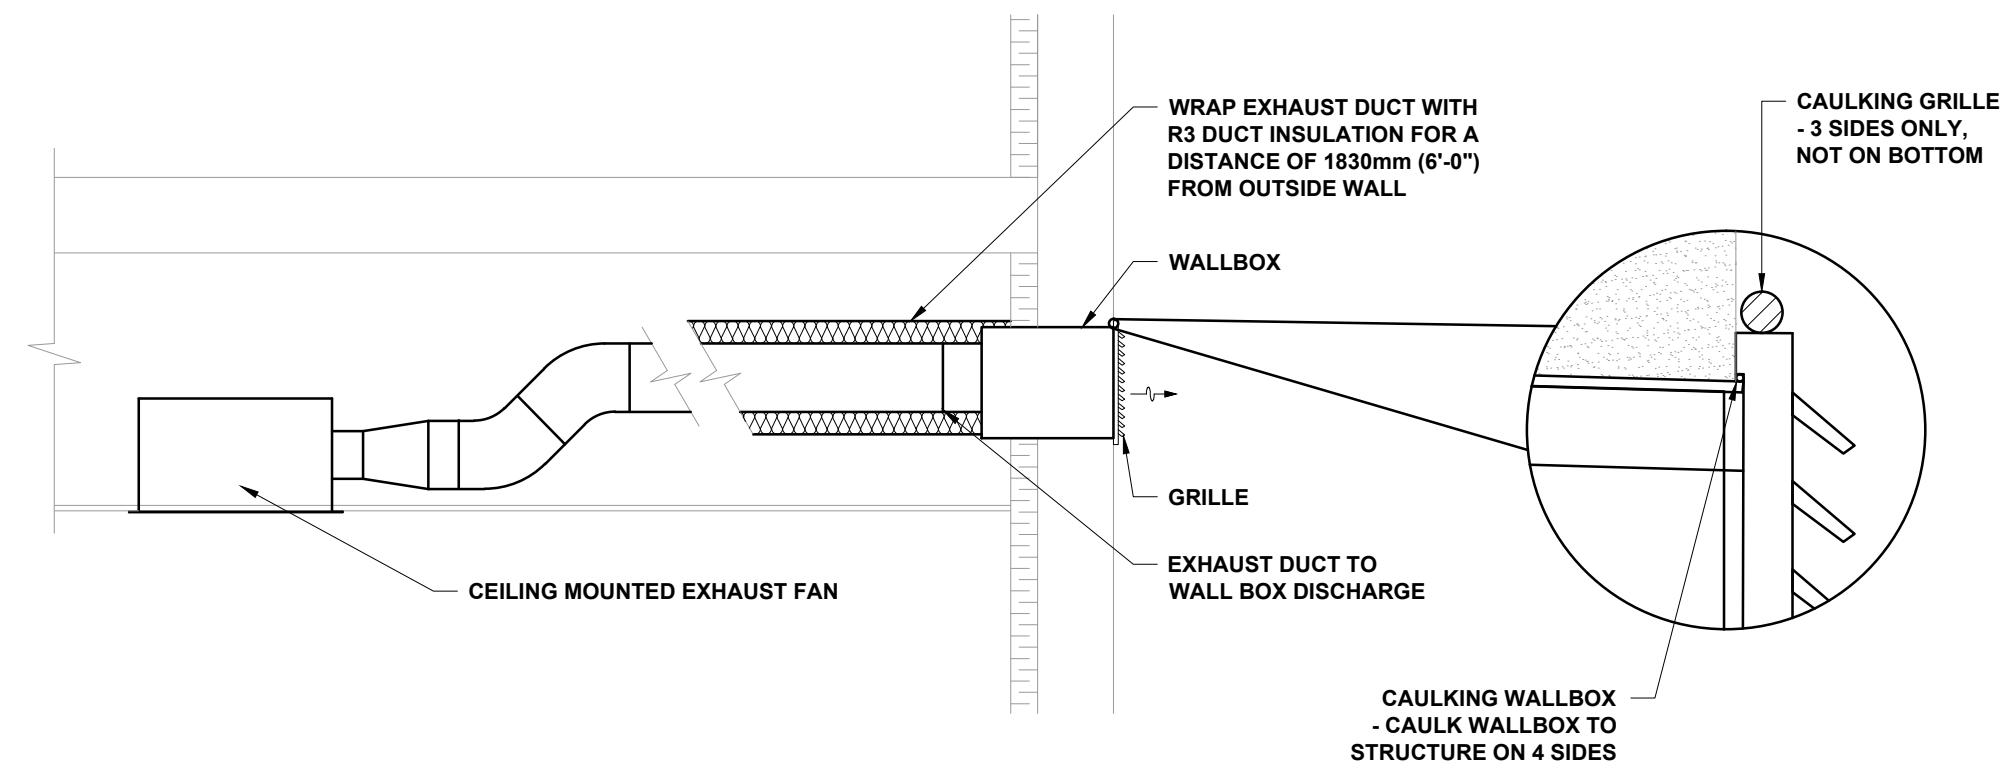


TYPICAL CEILING EXHAUST FAN TO WALL BOX DETAIL
N.T.S.

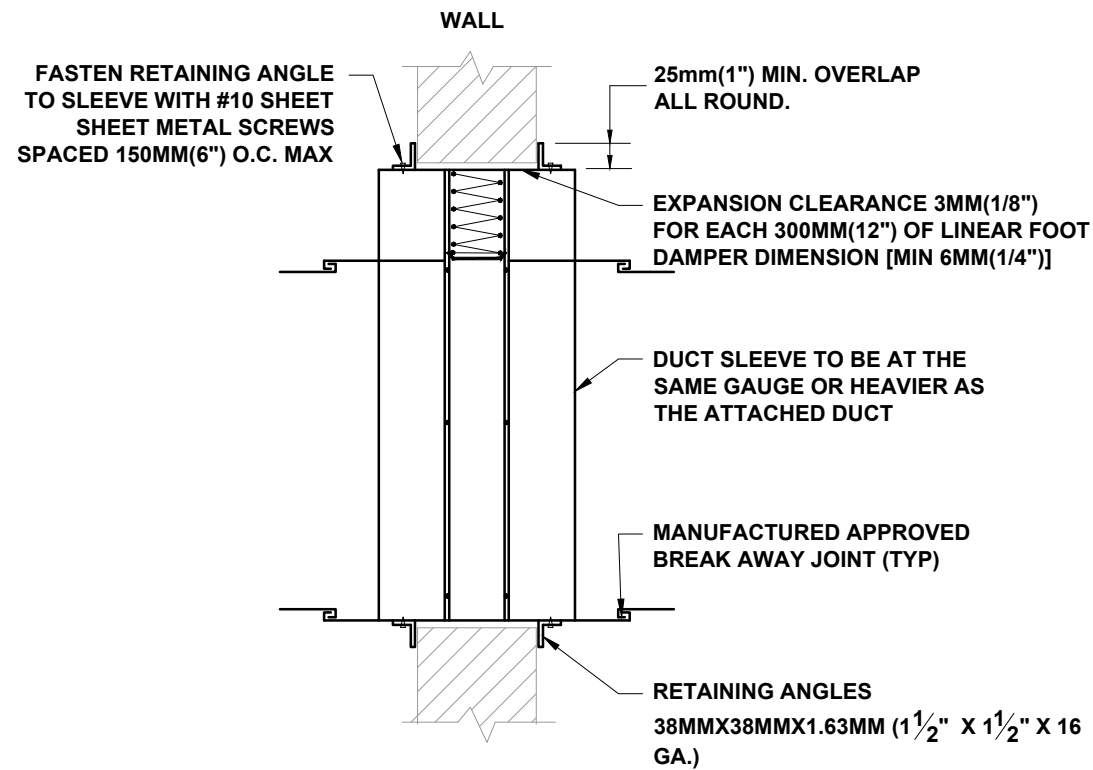


VERTICAL MOUNT DETAIL

FIRE DAMPER DETAIL
N.T.S.

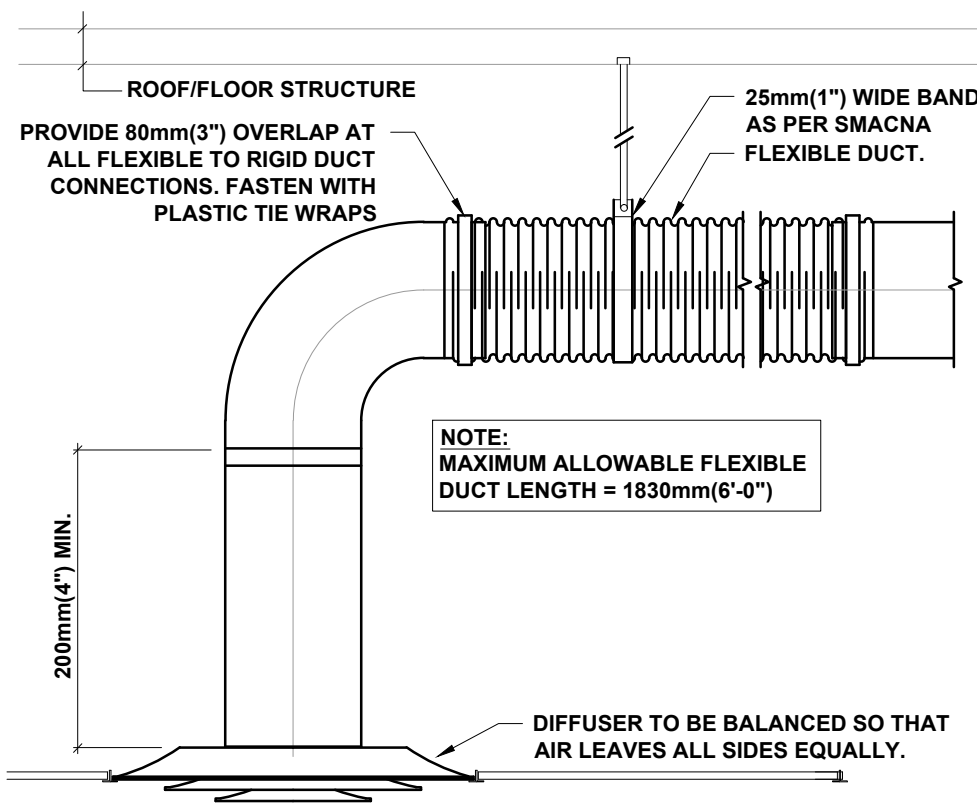

CEILING DIFFUSER INSTALLATION DETAIL
N.T.S.

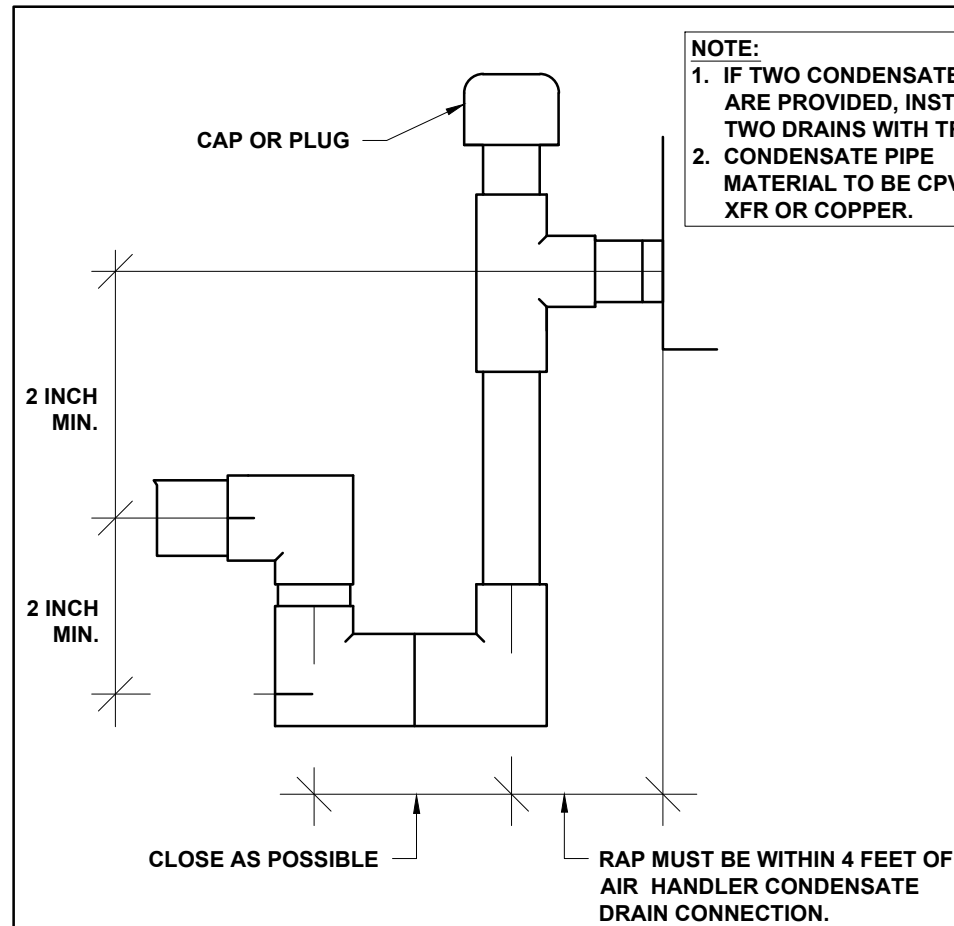

FURNACE CONDENSATE TRAP DETAIL
N.T.S.

GRILLE & DIFFUSER SCHEDULE

| DRAWING REFERENCE | MANUFACTURER | MODEL | PANEL SIZE | NECK SIZE | AIR RANGE [CFM] | REMARKS |
|-------------------|--------------|-------------|------------|-----------|-----------------|--|
| SD-1 CFM | E.H.PRICE | SCD/B12 | 12"x12" | 8"Ø | 0-200 | SUITABLE FOR T-BAR INSTALLATION. WHITE FINISH. |
| SD-2 CFM | E.H.PRICE | SCD/B12 | 24"x24" | 8"Ø | 150-300 | SUITABLE FOR T-BAR INSTALLATION. WHITE FINISH. |
| RG-1 CFM | E.H.PRICE | 80/TB/B12 | 12"x12" | - | 0-1000 | SUITABLE FOR T-BAR INSTALLATION. WHITE FINISH. |
| EG-1 CFM | E.H.PRICE | 530D/TB/B12 | 12"x12" | - | 0-200 | WHITE FINISH. SUITABLE FOR T-BAR INSTALLATION. C/W BALANCING DAMPER. |

NOTES:

- SEE SPECIFICATIONS FOR ACCEPTABLE MANUFACTURERS
- ALL BRANCH DUCTWORK SERVING DIFFUSERS TO BE THE SAME SIZE AS DIFFUSER NECK UNLESS SPECIFIED OTHERWISE
- THIS IS A STANDARD LEGEND, ALL SYMBOLS MAY NOT BE USED ON DRAWINGS .

CO & NO₂ SYSTEM EXHAUST RATE

- OVERALL SYSTEM AREA - 3960 SQ.FT (367.9 SQUARE METER)
- ASHRAE 62.1-2010 STATES THE FOLLOWING FOR THE SYSTEM:
0.75 CFM/SQ.FT X 3960 SQ.FT = 2970 CFM
- TOTAL REQUIRED EXHAUST RATE = 2970 CFM
- CO & NO₂ SYSTEM IS DESIGNED FOR STORAGE GARAGE USAGE ONLY, THE ENGINE MUST BE SHUT OFF WHEN VEHICLES ARE NOT IN MOTION.
- CO & NO₂ SYSTEM IS DESIGNED FOR ELECTRIC FORKLIFT OPERATIONS ONLY, OPERATIONS OF PROPANE OR GAS FUELED FORKLIFTS ARE PROHIBITED.

OFFICE VENTILATION SCHEDULE

- ANCILLARY SPACE OVERALL AREA - 918 SQ.FT (85.3 SQUARE METER)
- ASHRAE 62.1-2010 STATES THE FOLLOWING:
- FOR OFFICE:
5 CFM/PERSON x 9 PPL = 45 CFM
0.06 CFM/SQ.FT X 246 SQ.FT = 15 CFM
TOTAL REQUIREMENT = 60 CFM
- FOR DRY STORAGE:
5 CFM/PERSON x 1 PPL = 5 CFM
0.06 CFM/SQ.FT X 204 SQ.FT = 15 CFM
TOTAL REQUIREMENT = 20 CFM
- TOTAL VENTILATION REQUIREMENT = 80 CFM

WORKSHOP VENTILATION SCHEDULE

- WORKSHOP OVERALL AREA - 3960 SQ.FT (367.9 SQUARE METER)
- ASHRAE 62.1-2010 STATES THE FOLLOWING FOR WOOD/METAL SHOP:
10 CFM/PERSON x 10 PPL = 100 CFM
0.18 CFM/SQ.FT X 368 SQ.FT = 715 CFM
- TOTAL VENTILATION REQUIREMENT = 815 CFM

THE CONTRACTOR SHALL VERIFY ALL DIMENSIONS ON SITE. DO NOT SCALE DRAWINGS. DRAWINGS AND SPECIFICATIONS REMAIN THE PROPERTY OF THE ENGINEER AS INSTRUMENTS OF HIS SERVICE AND MUST BE RETURNED AT HIS REQUEST.

| 2 | ISSUED FOR TENDER | SEPT 6'17 |
|-----|-------------------------|-----------|
| 1 | ISSUED FOR OWNER REVIEW | AUG 25'17 |
| 0 | ISSUED FOR COORDINATION | AUG 18'17 |
| No. | REVISION | DATE |

MIDDLESEX COUNTY
399 RIDOUT STREET NORTH
LONDON, ON N6A 2P1



PROJECT # 17089

PUBLIC WORKS GARAGE
3550 EGREMONT DRIVE

STRATHROY

ONTARIO

SCHEDULES & DETAILS
-HVAC

| | |
|-------------|---------------|
| DRAWN: VL | SCALE: N.T.S. |
| DESIGN: VL | CHECKED: VL |
| DRAWING No. | REVISION: |
| M2.4 | R2 |

